
# Malahat Multipurpose Cultural Centre

## Malahat, BC

### **CONCEPTUAL SKETCH:**

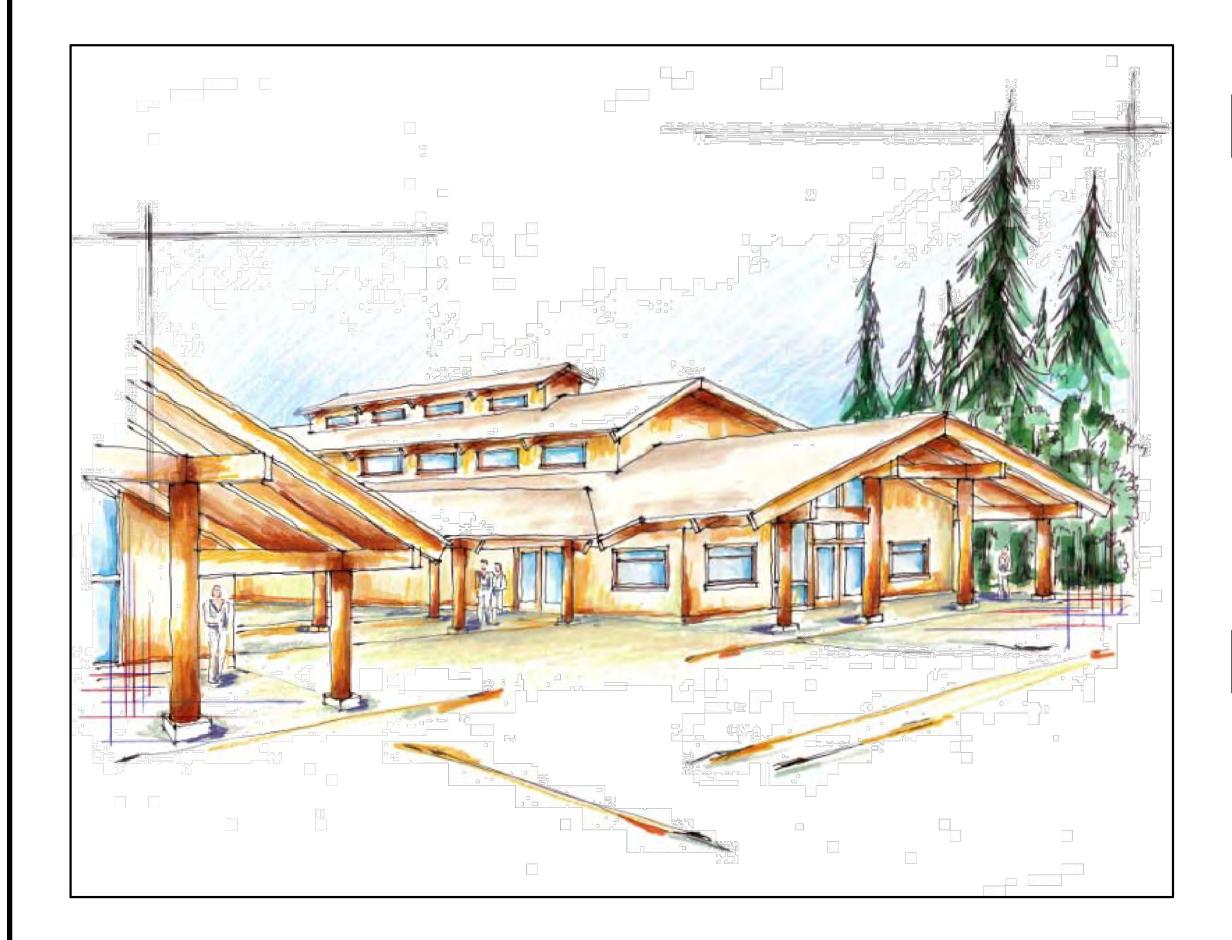

### PROJECT DATA:

PROJECT DESCRIPTION:
PROPOSED TWO-STOREY NEW MULTIPURPOSE CULTURAL
CENTRE BUILDING FOR MALAHAT FIRST NATION

### **PROJECT CONTACTS:**

<u>OWNER :</u> MALAHAT FIRST NATION

ARCHITECTURAL:

SCOTT M. KEMP ARCHITECT

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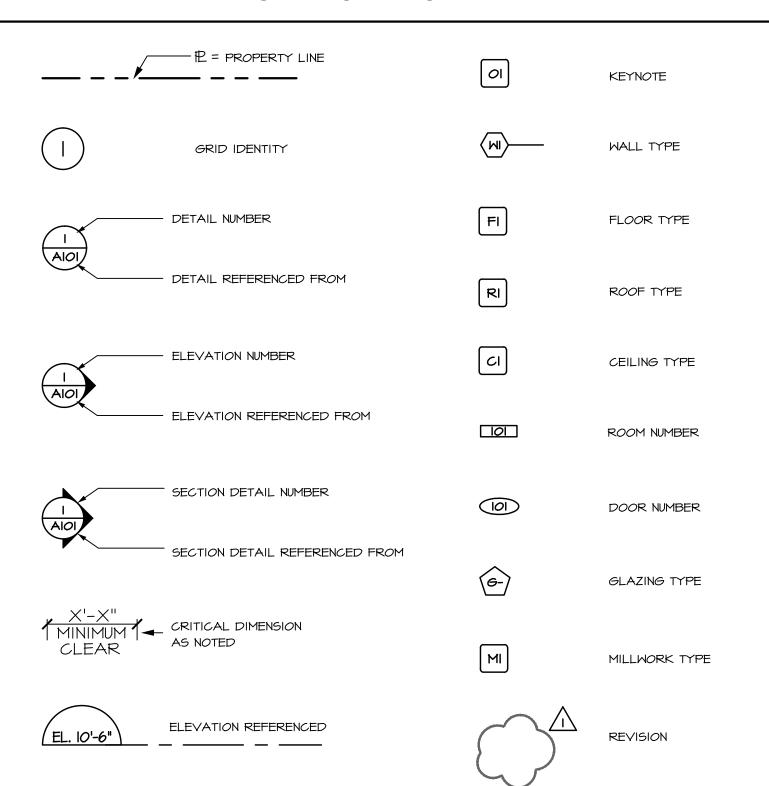
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NANAIMO, BC V95 3B3
TEL: (250) 756-4444
anthony@rbengineering.ca

### **SYMBOL LEGEND:**



### PROJECT DRAWING LIST:

A001	COVER SHEET
A002	CODE ANALYSIS
A003	CONSTRUCTION ASSEMBLIES
AI0I	SITE PLAN
 Al <i>0</i> 2	PARTIAL SITE PLAN
A201	FOUNDATION PLAN
A202	GROUND FLOOR PLAN
A202 A202A	PARTIAL GROUND FLOOR PLAN (MEDICAL WEST)
A202B	PARTIAL GROUND FLOOR PLAN (MEDICAL EAST)
A202C	PARTIAL GROUND FLOOR PLAN (DAYCARE)
A202D	PARTIAL GROUND FLOOR PLAN (ASSEMBLY EAST)
A202C	PARTIAL GROUND FLOOR PLAN (ASSEMBLY WEST)
A203	BEAM PLAN - ELEVATION + IO'-O"
A204	BEAM PLAN - ELEVATION + 14'-II"
A205	LOWER ROOF RAFTER PLAN
A206	SECOND FLOOR PLAN
A206A	PARTIAL SECOND FLOOR PLAN (ASSEMBLY)
A207	UPPER ROOF RAFTER PLAN
A208	ROOF PLAN
A301	EAST & SOUTH ELEVATIONS
A302	WEST & NORTH ELEVATIONS
A40I	CROSS SECTIONS A & B
A402	CROSS SECTION C
A501	WALL SECTIONS
	DETAILS
A60I	
A602	DETAILS
A603	WINDOW INSTALLATION SEQUENCE
A701	STAIR PLANS, SECTION & DETAIL
A801	ROOM FINISH SCHEDULE
A802	DOOR SCHEDULE, DOOR TYPES & DOOR FRAME TYPES
A803	WINDOW SCHEDULE
A901	ACCESSIBLE REQUIREMENTS
A1001	INTERIOR ELEVATIONS
Al <i>00</i> 2	INTERIOR ELEVATIONS
A1003	INTERIOR ELEVATIONS
Al004	INTERIOR ELEVATIONS
A1005	INTERIOR ELEVATIONS
A1006	INTERIOR ELEVATIONS
A1007	INTERIOR ELEVATIONS
A1008	INTERIOR ELEVATIONS
A1009	INTERIOR ELEVATIONS
A1010	INTERIOR ELEVATIONS
AIIOI	MILLWORK SECTIONS
/NIOI	

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DEC 15/17	ISSUED FOR INAC	_		
NOV 22/17	ISSUED FOR REVIEW	<u> </u>		
DATE	REMARKS	NO.		
DRAWING REVISIONS / ISSUES				

Scott M. Kemp Architect

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PROJECT

MALAHAT MULTIPURPOSE CULTURAL CENTRE

DRAWING TITLE

COVER SHEET

DRAWN ML	DATE MAR./I7
CHK'D 5K	JOB No
DESIGN	DRAWING No.
CHK'D _	A001
SCALE AS SHOWN	

Malahat Multi-Pur Outline Building Co BCBC 2012	pose Cultural Centre, M ode Analysis	<u>alahat, BC</u>		3.2.5.5(2)(a) 3.2.5.8	Building provided with fire department connection, a fire department pumper vehicle can be located adjacent to the hydrants (refer to article 3.2.5.15(2). A standpipe system is not required for the building		
Project: Proposed two storeys multi-purpose building with health centre, daycare centre and recreational centre.		3.2.5.15(2)	The fire department connection for an automatic sprinkler system shall be located so that the distance from the fire department connection to a hydrant is not more than 147.6 m and is unobstructed.				
1.4.1.2	Building Area	10,676 sq ft		3.2.5.16(1)	Portable fire extinguishers to be provided and installed in accordance with British Columbia Fire Code		
1.4.1.2	Building Height	2 storeys		3.2.7	Lighting and Emergency Power Systems		
3.1.2.1	Major Occupancy	A2-Assembly		3.2.7.1(1)	The exits and corridors providing access to exit to have a minimum illumination of 50 Lx at the floor		
		B3 Care D Business and Personal Servic	es Occupancies	3.2.7.3(1)	Emergency lighting to be provided in exits, routes providing access to exits, corridors, lounge, gymnasium, mezzanine/viewing platform, meeting room and		
3.1.17	Occupant Load Gross floor area = 10,676 sq ft:		3.3	gym to minimum 10 Lx at floor level provided for a minimum of 30 minutes  Safety Within Floor Areas			
	A2 Assembly occupant	-		3.3.1.1 3.3.1.5(1)(b)	The building is considered as one suite.  Minimum 2 egress doorway required for Multi-Game Court.		
	Office Kitchen	155 sq.ft./100.1= 305 sq.ft./100.1 =	2 persons 4 persons	3.3.1.5(1)(b)	A single egress doorway is permitted from other rooms as the occupant load of each room is less than 60,		
	Multi-Game Court	1,735 sq.ft./10.23=	170 persons	3.3.1.5(1)(d)(i & ii)	The travel distance to the egress doorway is less than 82.0' and the rooms are less		
	Lounge Pantry/Storages	813 sq.ft./19.91= 263/495=	41 persons 1 person	3.3.1.11(2)	than 1,076 sq ft in area each The egress doorways from all rooms do not have to swing in the direction of travel		
	Total occupant load		218 persons	3.3.1.13(10)(b)(i)	to an exit as the occupant load of each room is less than 60 persons Doors providing access swinging <u>in</u> to have a clear and level area 5'-0" long		
	Daycare Kitchen	1,117 sq.ft./107.64= 85/100.1=	11 persons 1 persons	3.3.1.13(10)(b)(ii)	with a minimum of 2'-0" clear space on the latch side of the door.  Doors providing access swinging out to have a clear and level area 4'-0" long		
	Storages Total occupant load	134/495=	1 person 13 persons	3.3.1.17(2)	with a minimum of 1'-0" clear space on the latch side of the door.  The width of corridors and doorways far exceeds the minimum widths required for		
	_	al Services occupant load:	p>	3.3.1.21(3)	capacity of access to exits in all area (6.1mm/persons)  The janitor room is to be separated from the rest of the floor area by a fire		
	Reception/Offices	988 sq.ft./100.1=	10 persons	3.3.1.21(3)	separation with 0 hour fire resistance rating required.		
	Exam Rooms Storages	508/100.1 353/495=	6 persons 1 person				
	Total occupant load		17 persons	3.4 3.4.2.1(1)	Exits At least 2 exits are provided from building		
	Entrance, lobby, waiting	g, meeting rooms, corridor, lounge, jar	nitor, and washrooms	3.4.2.5(1)(b)(c)	The travel distance from any point to at least one exit is <131.2' for business and personal services occupancy and <147.63' for other occupancies.		
	are transitory occupanci		,	3.4.3.2(1) 3.4.4.2(2)	The doorway, corridor width and stair width exceed the occupant load requirements Exit through lobby.		
3.2.2 3.2.2.26	Building Size and Construction Relative to Occupancy Group A, Division 2, up to 2 Storeys, Sprinklered Sprinklered throughout Not more than 2 storeys Not more than 25,833 sqft in building area			3.4.5.1	Exit through 1000y.  Exits signs are required and provided at all exit doors and in the egress corridors  Every exit sign shall consist of a green pictogram and white or lightly tinted		
3.2.2.26(1)(a)				graphical symbol meeting the colour specifications referred to in ISO 3864-1, "Graphical symbols – Safety colours and safety sign – Part 1: Design principles for safety signs in workplaces and public areas,"			
3.2.2.26(1)(b) 3.2.2.26(1)(c)(ii)							
3.2.2.26(2) 3.2.2.26(2)(a)		abustible construction permitted have 45 min fire separation if of combu	ustible construction	3.4.5.1(2)(c)	Every exit sign to conform to the dimensions indicated in ISO 7010, "Graphical symbols – Safety colours and safety signs – Safety signs in workplaces		
3.2.2.26(2)(c))(i)(ii)	Loadbearing walls, colu	umns and supports shall have fire resiste construction	tance rating of 45 min	3.4.6.16(2)(a)	All egress/exit doors from multi-game court and all exit doors to have door "panic" release hardware		
3.2.2 3.2.2.45		struction Relative to Occupancy		3.6.2 3.6.2.1(2)	Service Rooms Service rooms with fuel-fired appliances that serves only 1 suite not required to be		
3.2.2.45 3.2.2.45(1)(a)	Sprinklered throughou				separated from the rest of the building		
3.2.2.45(1)(b) 3.2.2.45(1)(c)(ii)	Not more than 2 store Not more than 17,222	sqft in building area		3.6.2.1(8)	Service rooms contains service equipment, and the service equipment constitutes a fire hazard or is essential to the operation of fire safety systems (i.e. sprinkler		
3.2.2.45(2) 3.2.2.45(2)(a)	Floor assemblies shall	mbustible construction permitted have 45 min fire separation			system) in the building is required to be separated from the rest of the building by 1 hour fire separation		
3.2.2.45(2)(c))(i)(ii)	Loadbearing walls, col assembly	lumns and supports shall be not less	than supported	3.7	Health Requirements		
3.2.2		truction Relative to Occupancy		3.7.2.2(6)	Assembly occupancy: based on an occupant load of 218 persons, 3 male water closets and 5 female water closets required. Provided are 4 male water closets and 4		
3.2.2.61 3.2.2.61(1)(a) 3.2.2.61(1)(b)	Group D, up to 2 Storey Sprinklered throughout Not more than 2 storey				female water closets and an accessible toilet room.  Care occupancy: based on an occupant load of 13 persons, 1 male water closet and		
3.2.2.61(1)(c)(ii) 3.2.2.61(2)	Not more than 25,833 se Combustible or noncom	abustible construction permitted			1 female water closet required. Provided 5 universal water closets.		
3.2.2.61(2)(a) 3.2.2.61(2)(b))(i)(ii)	Floor assemblies shall h	have 45 min fire separation if of combumns and supports shall have fire resist			D occupancy: based on an occupant load of 17 persons, 1 male water closet and 1 female water closet required. Provided are 4 male water closets and 4 female water closets and an accessible toilet room with shower.		
3.2.2.45 building cla	assification governs as th	is is the most restrictive: B3 Care O	<u>Occupancy</u>	3.8 3.8.2.1(1)	Building Requirements for Persons With Disabilities The building shall be accessible		
3.2.3 Table 3.2.3.1.D	Spatial Separation and I Face area 1.	Exposure Protection d. upo permitted construct	ion rea'd	3.8.2.3(1)(a) 3.8.2.3(1)(b)	Access is provided from the street to the main entrance.  Accessible parking is provided in the parking		
1 αυις 3.2.3.1.D	North V	vacant 100% 0 min. f.r	r.r	3.8.2.3(2)(a)	Universal toilet room provided.		
	South 4	1.43' 100% 0 min. f.r 0.84' 100% 0 min. f.r	r.r.	3.8.2.3(2)(b)	With the building occupant load exceeding 150, all other public washrooms are also required to be accessible in the A2 occupancy except daycare facility has the		
	East S	treet 100% 0 min. f.r	r.	3.8.3.5(4)(c)	washroom are not for public use.  A power operated door is required at front entry in both		
3.2.4 3.2.4.1(1)	Fire Alarm and Detection A fire alarm system is re	on Systems equired as the building is sprinklered.			directions.		
3.2.4.5(1)		nstalled to CAN/ULC-S524 "Installat	ion of Fire Alarm				
3.2.4.5(2)	The fire alarm is to be v	verified to CAN/ULC-S537 "Verificati	ion of Fire Alarm				
3.2.4.8(4)	Systems". The fire alarm system is	s to be designed to notify the fire depart	rtment to ceiving Centres				

and Systems".

3.2.4.9(1) A fire alarm annunciator is to be installed near the principal entrance.

3.2.4.12(1)(e) Smoke detectors are required in each exit stair shaft.

Manual (pull) stations are required at the principal entrance and at every exit.

Provisions for Firefighting
An access route for fire department vehicles is provided to the principal

The access route is to be between 9.84' and 49.2' of the principal entrance

3.2.5

3.2.5.4(1)(a)

3.2.5.5(1)

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NOV 22/17	ISSUED FOR REVIEW			
DATE	REMARKS	NO.		
DRAWING REVISIONS / ISSUES				

Scott M. Kemp Architect

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PROJECT

MALAHAT MULTIPURPOSE CULTURAL CENTRE

Malahat, BC

DRAWING TITLE

CODE ANALYSIS

DRAWN ML

CHK'D SK

DESIGN

DRAWING No.

CHK'D \_

SCALE AS SHOWN

DATE MAR./IT

ARAP./IT

MAR./IT

ARAP./IT

ARAP./IT

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ARAP./IT

ARAP./IT

WALL TYPES TO BE READ IN CONJUNCTION W/WALL NOTATIONS ON THIS SHEET

DOOR TYPE - SEE DOOR SCHEDULE

GLAZING TYPE - SEE WINDOW SCHEDULE IOI ROOM NUMBER - SEE ROOM FINISH SCHEDULE

FLOOR TYPE - SEE FLOOR TYPES

### **WALL TYPES:**

FOUNDATION WALL ASSEMBLY:
- I" R5 RIGID INSULATION - DAMPPROOFING - 2X8 WOOD STUDS @ 16" O.C. - 8" CONCRETE WALL

FOUNDATION WALL ASSEMBLY:
- 8" CONCRETE WALL

TYP. EXTERIOR WALL ASSEMBLY:
- BOARD AND BATTEN SIDING - I/2" P.T. STRAPPING - I" R5 RIGID INSULATION

- MOISTURE BARRIER - 1/2" PLYWOOD SHEATHING - 2X6 WOOD STUDS @ 16" O.C. - R22 BATT INSULATION

- 6 MIL V.B. - 1/2" GYPSUM BOARD (5/8" FOR ALL LOADBEARING WALLS)

COURT EXTERIOR WALL ASSEMBLY:
- BOARD AND BATTEN SIDING

- I/2" P.T. STRAPPING - I" R5 RIGID INSULATION - MOISTURE BARRIER

- 1/2" PLYWOOD SHEATHING - 2X8 WOOD STUDS @ 16" O.C. - R28 BATT INSULATION

- 6 MIL V.B. - 1/2" GYPSUM BOARD

TYP. INTERIOR WALL ASSEMBLY:
- I/2" GYPSUM BOARD (BOTH SIDES) - 2X4 WOOD STUDS @ 16" O.C.

- COURT INTERIOR WALL ASSEMBLY:
   1/2" GYPSUM BOARD (BOTH SIDES)
- W4 INTERIOR WALL ASSEMBLY:
   I/2" TYPE 'X' GYPSUM BOAR - 1/2" TYPE 'X' GYPSUM BOARD (BOTH SIDES) - 2X6 WOOD STUDS @ 16" O.C.
- L HOUR F.R.R. INTERIOR WALL ASSEMBLY ULC #W310: - 5/8" TYPE 'X' GYPSUM BOARD (BOTH SIDES) - 2X4 WOOD STUDS @ 16" O.C. - FIRE RETARDANT PLYWOOD AS REQUIRED FOR EQUIPMENT SUPPORT ON WALL
- I HOUR F.R.R. INTERIOR WALL ASSEMBLY <u>ULC #W310:</u> - 5/8" TYPE 'X' GYPSUM BOARD (BOTH SIDES) - 2X8 WOOD STUDS @ 16" O.C. - FIRE RETARDANT PLYWOOD AS REQUIRED FOR EQUIPMENT SUPPORT ON WALL

ALL LOADBEARING WALLS, POSTS, COLUMNS & SUPPORTS TO HAVE 45 MIN. F.R.R. - USE 5/8" TYPE 'X' GWB IN-LIEU OF 1/2" *G*MB

### **ROOF TYPES:**

RAFTERS SOFFIT ASSEMBLY:
- STANDING SEAM METAL ROOF SYSTEM

- R20 RIGID INSULATION (EFFECTIVE R20)

- PLYWOOD SHEATHING PER STRUCT. ENG.

ROOF MEMBRANE

- VAPOUR RETARDER

- 2X6 WOOD DECKING - ROOF RAFTERS

- RAFTERS ROOF ASSEMBLY:
   STANDING SEAM METAL ROOF SYSTEM
   ROOF MEMBRANE - R20 RIGID INSULATION (EFFECTIVE R20)
- VAPOUR RETARDER - PLYWOOD SHEATHING PER STRUCT. ENG. - 2X6 ROOF DECKING (T&G) - ROOF RAFTERS
- R2 GYM ROOF ASSEMBLY:
   STANDING SEAM METAL ROOF SYSTEM
   ROOF MEMBRANE - ROOF MEMBRANE - R20 RIGID INSULATION (EFFECTIVE R20) - VAPOUR RETARDER
  - PLYWOOD SHEATHING PER STRUCT. ENG. - 2X6 ROOF DECKING (T&G) - ROOF TRUSSES SYSTEM (EXPOSED STEEL TO BE PAINTED)

### **FLOOR TYPES:**

- FI SLAB-ON-GRAD FLOOR ASSEMBLY:
   FLOOR FINISH - SLAB-ON-GRADE PER STRUCT.
- 6 MIL POLY V.B. - RIO RIGID INSULATION - COMPACTED SOIL
- F2 FLOOR ASSEMBLY (TYP.):
   FLOOR FINISH
   3/4" PLYWOOD SHEATHIN - 3/4" PLYWOOD SHEATHING
- FLOOR JOIST PER STRUCT. ENG. - 5/8" TYPE 'X' GYPSUM BOARD 45 MIN. FIRE SEPARATION (BCBC ACCUMULATIVE METHOD)

DEC 15/17 ISSUED FOR INAC NOV 22/17 ISSUED FOR REVIEW

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REMARKS DRAWING REVISIONS / ISSUES

Scott M. Kemp Architect

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PROJECT


MALAHAT MULTIPURPOSE CULTURAL CENTRE

Malahat, BC

DRAWING TITLE CONSTRUCTION ASSEMBLIES

DATE MAR./IT CHK'D SK JOB No. DESIGN CHK'D \_ A003 SCALE AS SHOWN



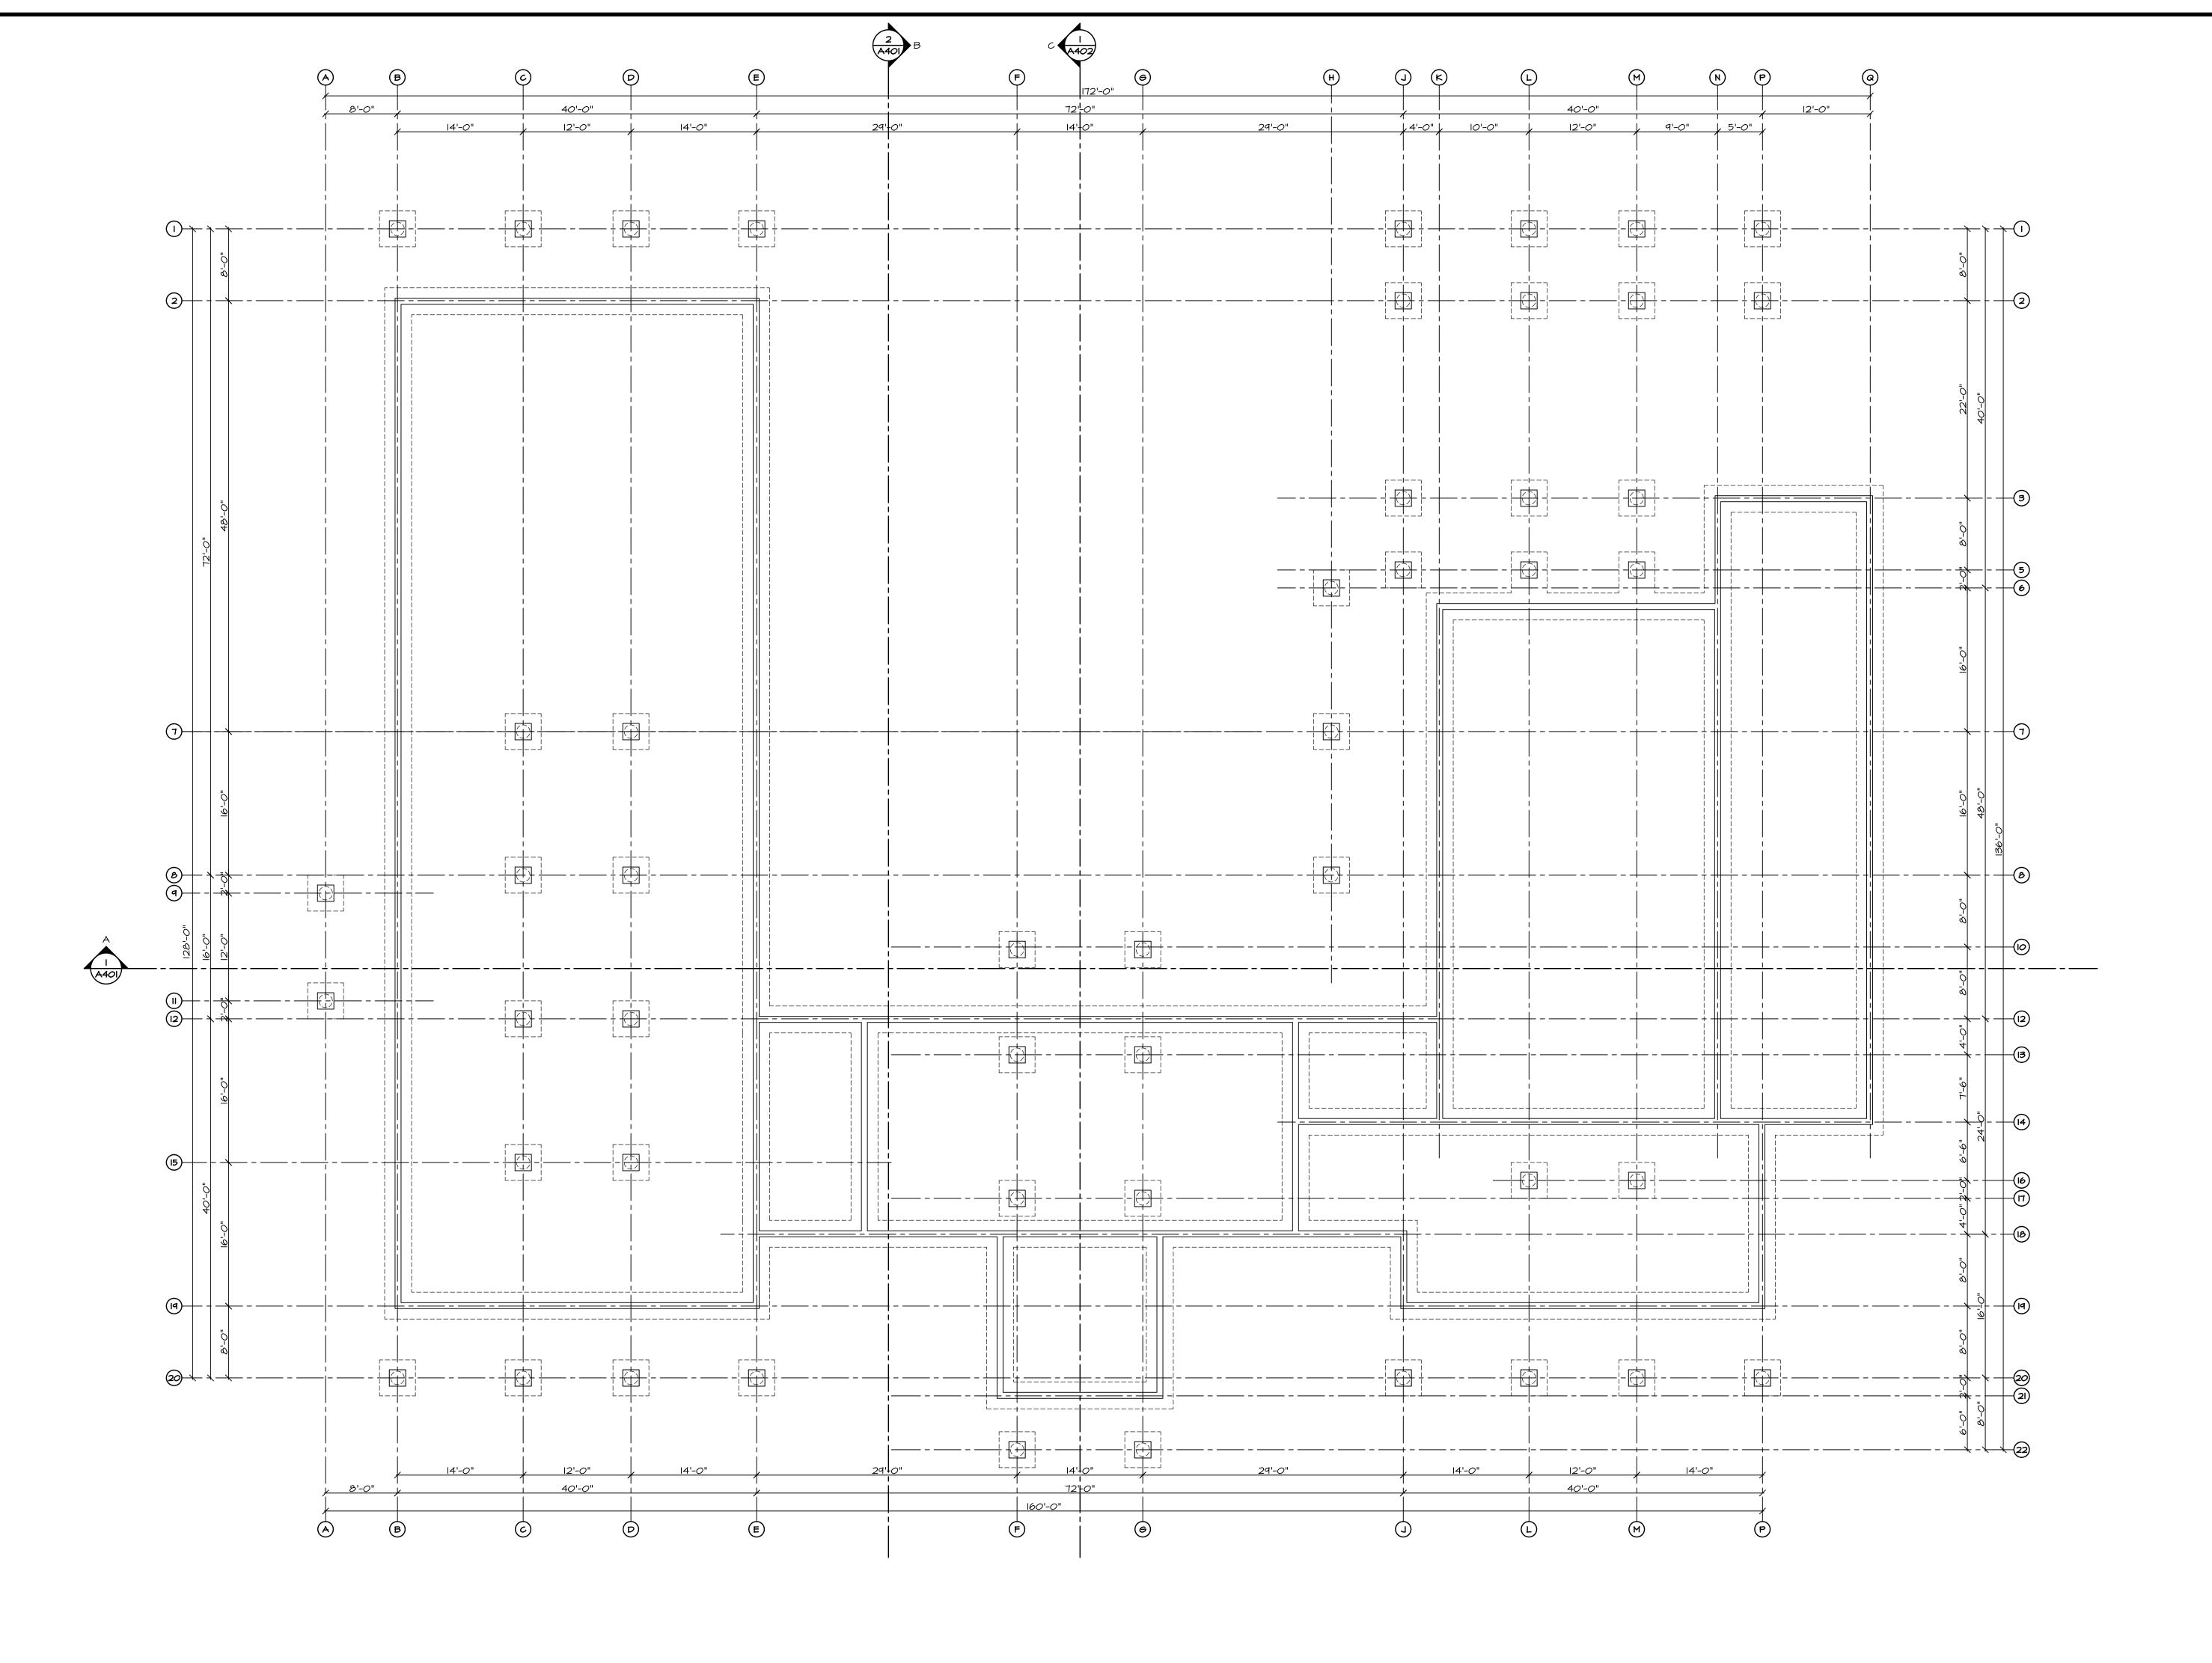

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DEC 15/17	ISSUED FOR INAC	<u>_</u>			
NOY 12/17	ISSUED FOR REVIEW	<u>_</u>			
SEP. 17/17	ISSUED FOR REVIEW	<u>_</u>			
AUG OI/IT	ISSUED FOR REVIEW	<u>_</u>			
JULY 19/17	ISSUED FOR REVIEW				
DATE	REMARKS	NO.			
DRAWING R	DRAWING REVISIONS / ISSUES				

### Scott M. Kemp Architect

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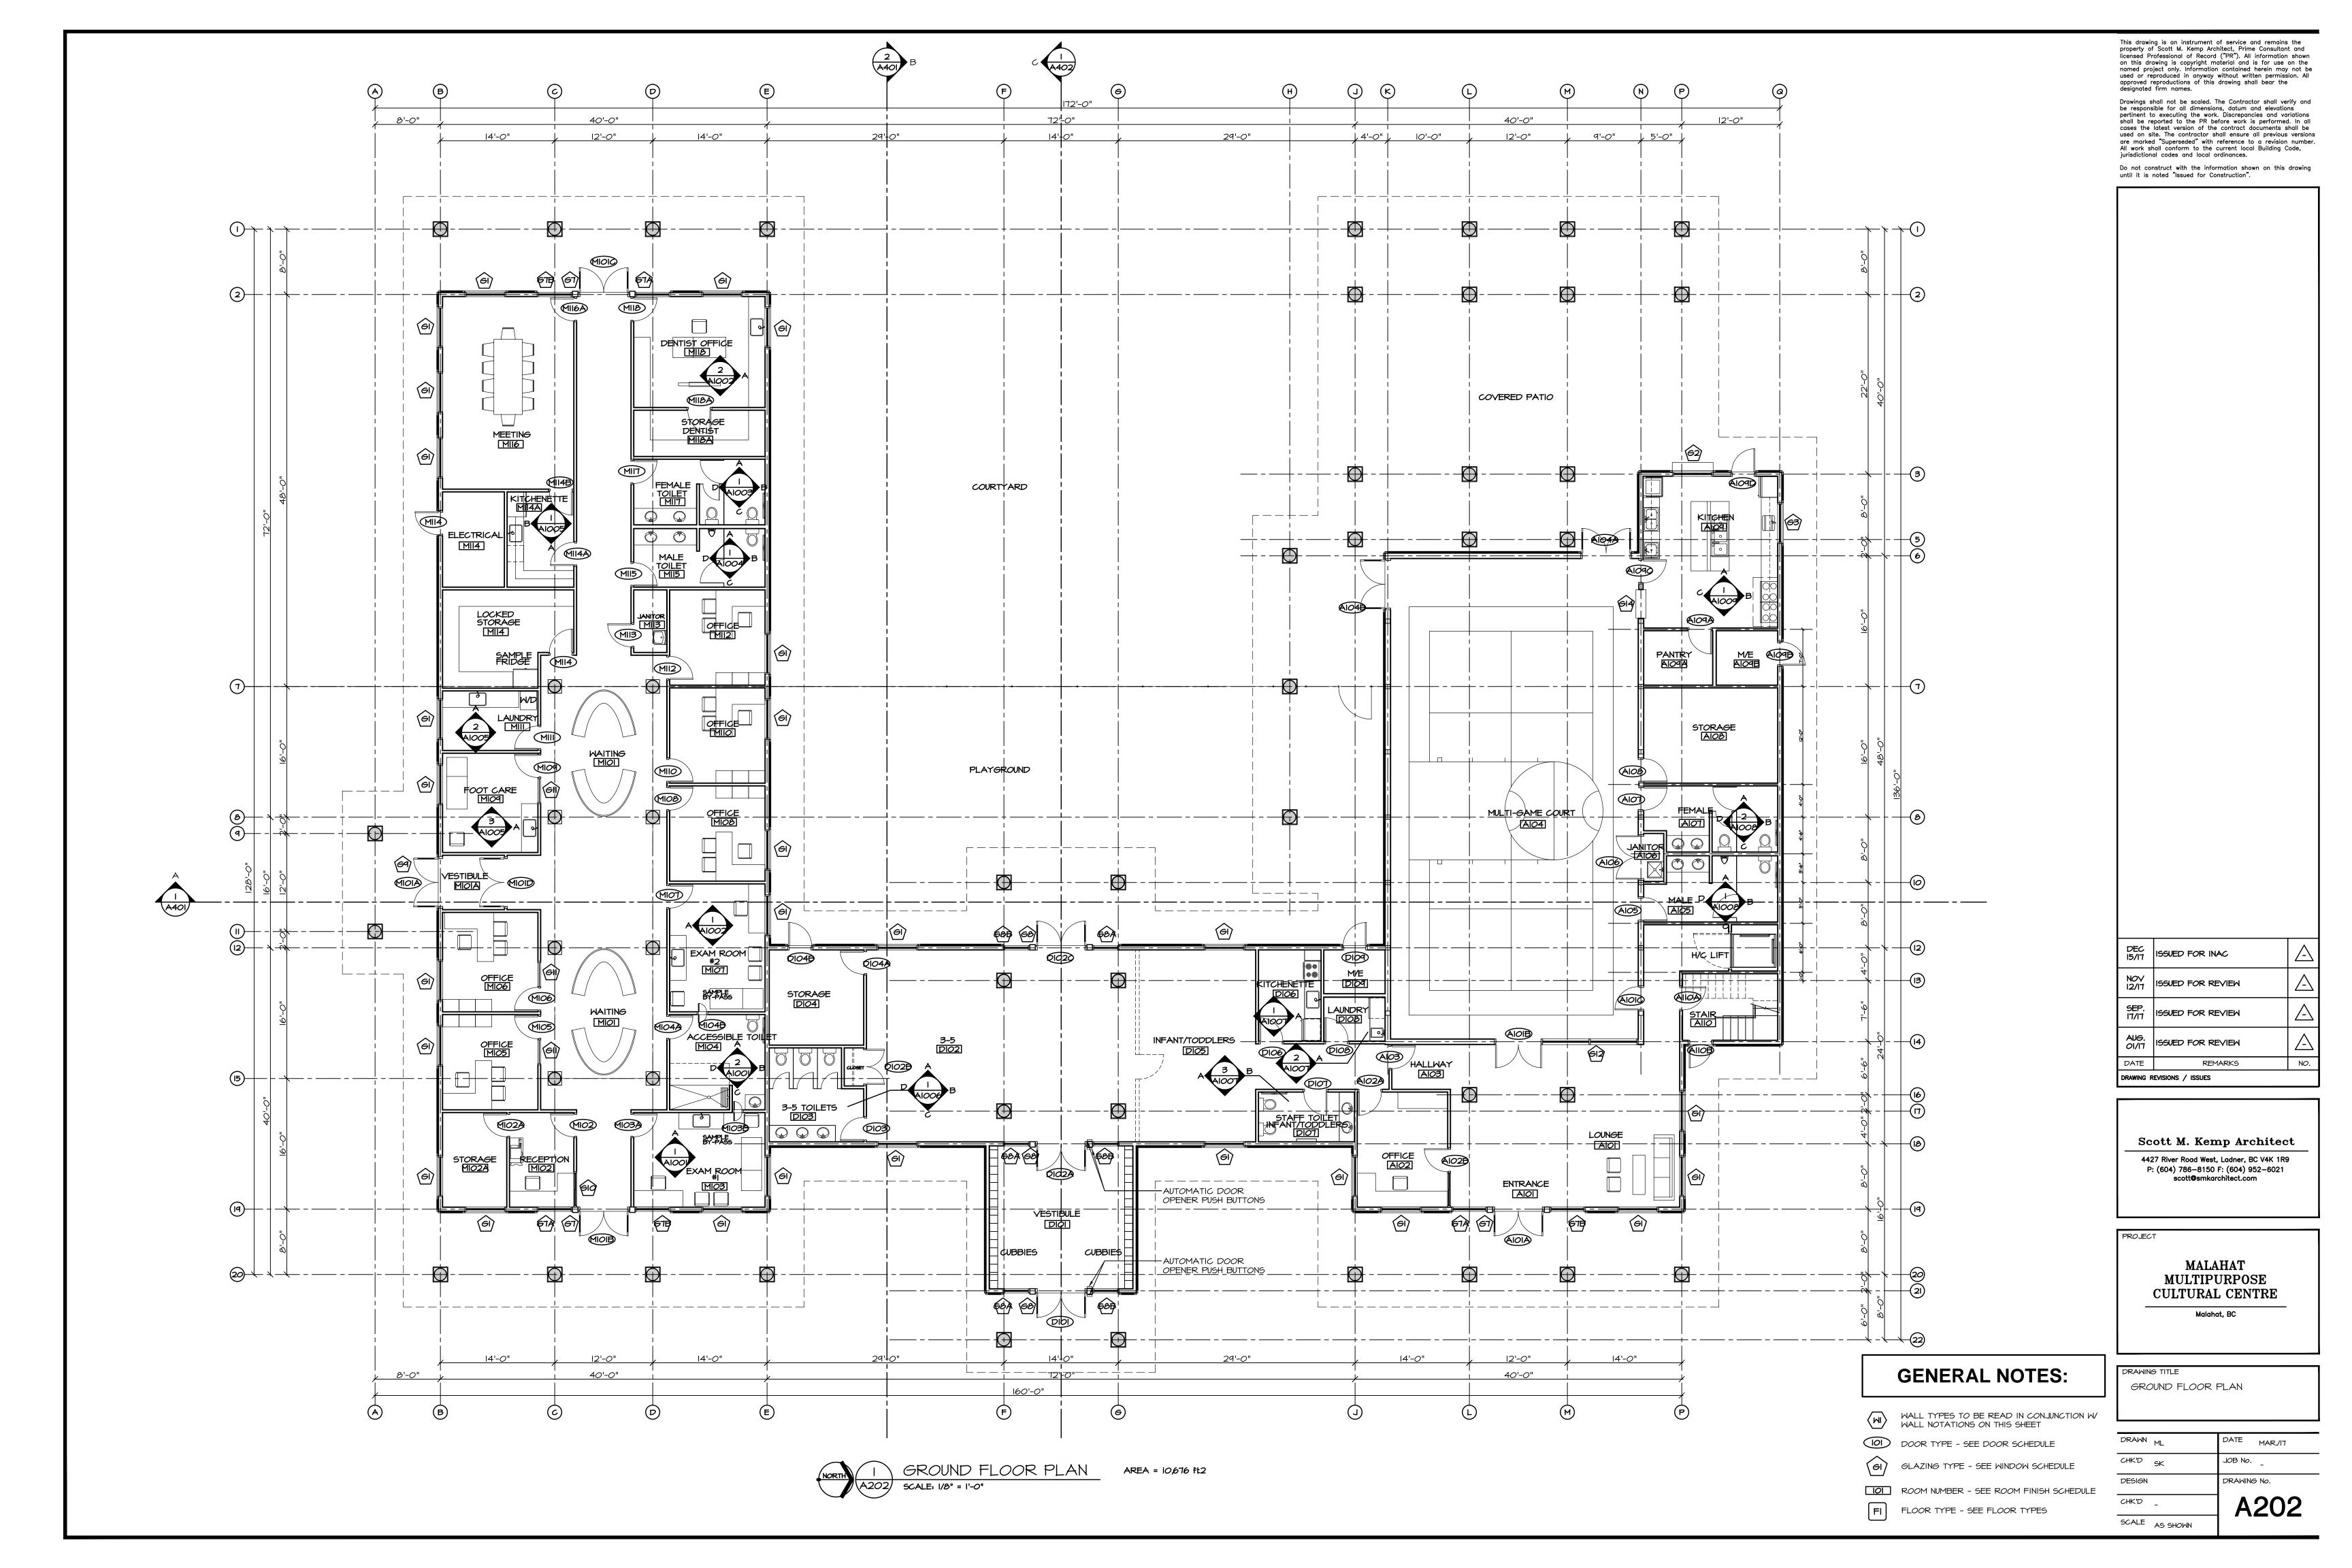
PROJECT


MALAHAT MULTIPURPOSE CULTURAL CENTRE

Malahat, BC

DRAWING TITLE
FOUNDATION PLAN

DRAWN	ML	DATE	AUG/IT
CHK'D	5K	JOB No.	-
DESIGN		DRAWING	No.
CHK'D	-	Α	201
SCALE	AS SHOWN		



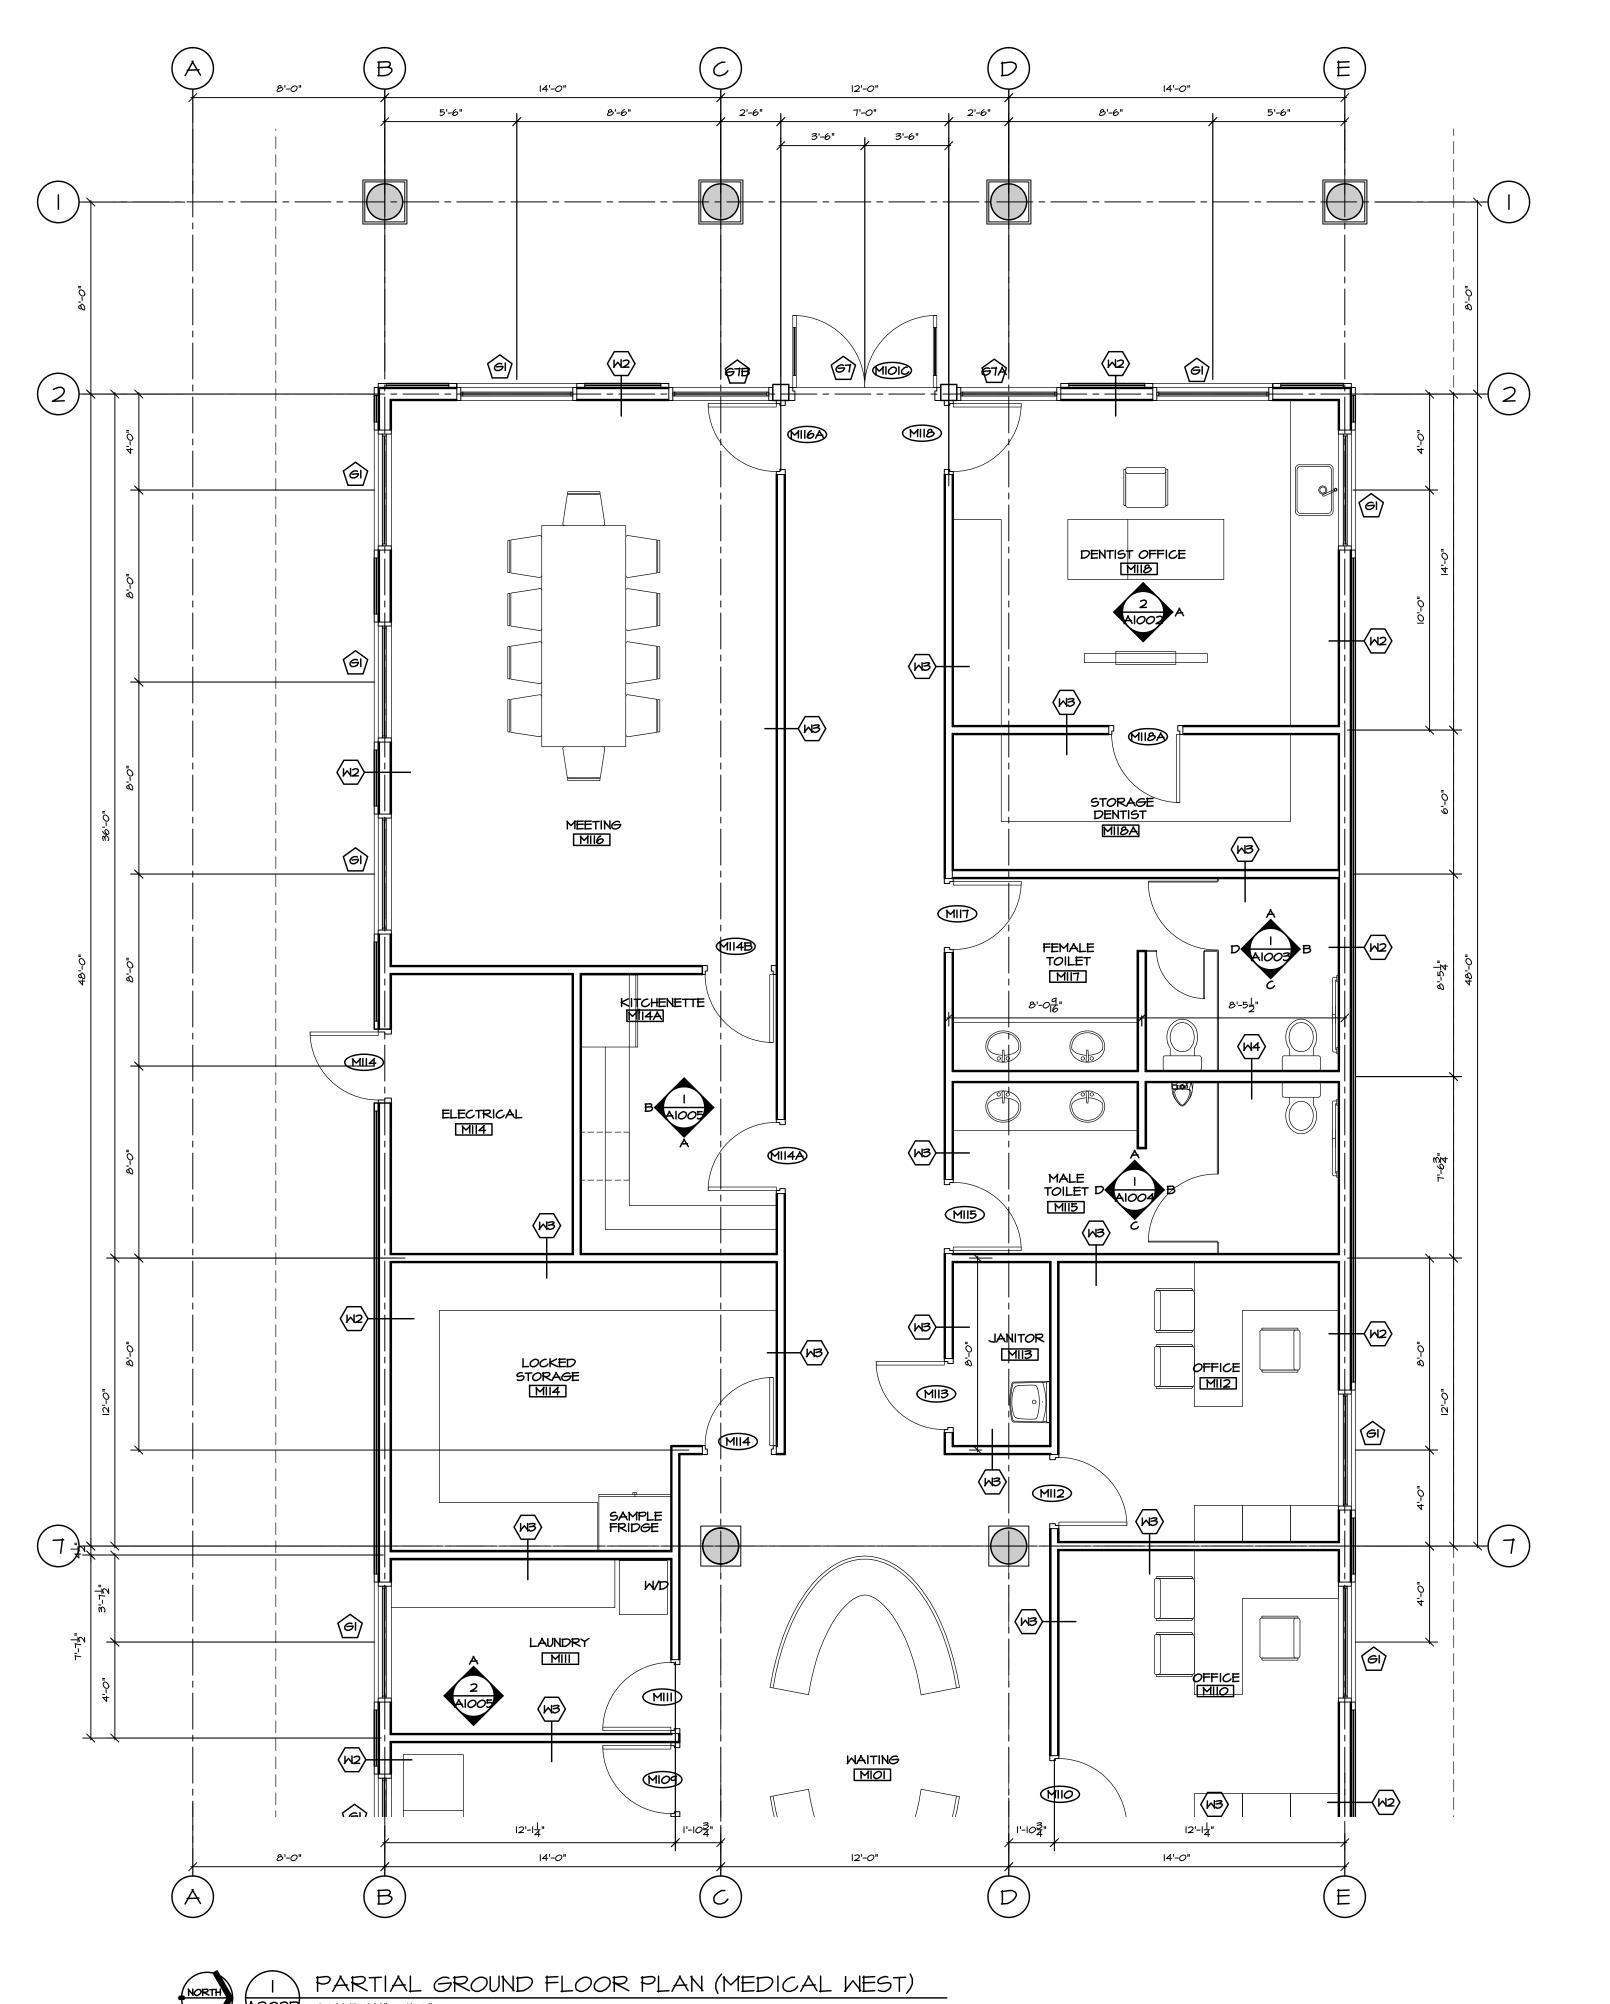

- WALL TYPES TO BE READ IN CONJUNCTION W/ WALL NOTATIONS ON THIS SHEET
- DOOR TYPE SEE DOOR SCHEDULE
- GLAZING TYPE SEE WINDOW SCHEDULE
- ROOM NUMBER SEE ROOM FINISH SCHEDULE
- FLOOR TYPE SEE FLOOR TYPES

- FOUNDATION WALL ASSEMBLY:
   I' R5 RIGID INSULATION - DAMPPROOFING - 8" CONCRETE WALL
- FOUNDATION WALL ASSEMBLY:
   8" CONCRETE WALL
- TYP. EXTERIOR WALL ASSEMBLY:
   BOARD AND BATTEN SIDING - I/2" P.T. STRAPPING - I" R5 RIGID INSULATION - MOISTURE BARRIER - I/2" PLYWOOD SHEATHING
- 2X6 WOOD STUDS @ 16" O.C. - R22 BATT INSULATION - 6 MIL V.B. - 1/2" GYPSUM BOARD (5/8" FOR ALL LOADBEARING WALLS)
- COURT EXTERIOR WALL ASSEMBLY:
   BOARD AND BATTEN SIDING
   I/2" P.T. STRAPPING - I" R5 RIGID INSULATION - MOISTURE BARRIER
  - 1/2" PLYWOOD SHEATHING - 2X8 WOOD STUDS @ 16" O.C. - R28 BATT INSULATION - 6 MIL V.B. - 1/2" GYPSUM BOARD
- TYP. INTERIOR WALL ASSEMBLY:
   1/2" GYPSUM BOARD (BOTH SIDE - 1/2" GYPSUM BOARD (BOTH SIDES) - 2X4 WOOD STUDS @ 16" O.C.

### **WALL TYPES:**

- COURT INTERIOR WALL ASSEMBLY:
   1/2" GYPSUM BOARD (BOTH SIDES) - 2X8 WOOD STUDS @ 16" O.C.
  - W4 INTERIOR WALL ASSEMBLY:
     I/2" TYPE 'X' GYPSUM BOAR - I/2" TYPE 'X' GYPSUM BOARD (BOTH SIDES) - 2X6 WOOD STUDS @ 16" O.C.
  - WE L HOUR F.R.R. INTERIOR WALL ASSEMBLY ULC #W310:
  - 5/8" TYPE 'X' GYPSUM BOARD (BOTH SIDES) - 2X4 WOOD STUDS @ 16" O.C. - FIRE RETARDANT PLYWOOD AS REQUIRED FOR EQUIPMENT SUPPORT ON WALL
  - L HOUR F.R.R. INTERIOR WALL ASSEMBLY
    ULC #W310: - 5/8" TYPE 'X' GYPSUM BOARD (BOTH SIDES) - 2X8 WOOD STUDS @ 16" O.C.

FOR EQUIPMENT SUPPORT ON WALL

- FIRE RETARDANT PLYWOOD AS REQUIRED

ALL LOADBEARING WALLS, POSTS, COLUMNS & SUPPORTS TO HAVE 45 MIN. F.R.R. - USE 5/8" TYPE 'X' GWB IN-LIEU OF 1/2" *G*WB

### **ROOF TYPES:**

- RI RAFTERS ROOF ASSEMBLY:
   STANDING SEAM METAL RO - STANDING SEAM METAL ROOF SYSTEM
  - ROOF MEMBRANE - R20 RIGID INSULATION (EFFECTIVE R20) - VAPOUR RETARDER
  - PLYWOOD SHEATHING PER STRUCT. ENG. - 2X6 ROOF DECKING (T&G) - ROOF RAFTERS
- R2 GYM ROOF ASSEMBLY:
   STANDING SEAM METAL ROOF SYSTEM - ROOF MEMBRANE - R20 RIGID INSULATION (EFFECTIVE R20) - VAPOUR RETARDER
- PLYWOOD SHEATHING PER STRUCT. ENG. - 2X6 ROOF DECKING (T&G) - ROOF TRUSSES SYSTEM (EXPOSED STEEL TO BE PAINTED)
- SI RAFTERS SOFFIT ASSEMBLY:
   STANDING SEAM METAL ROOF SYSTEM - ROOF MEMBRANE - R20 RIGID INSULATION (EFFECTIVE R20)
- VAPOUR RETARDER - PLYWOOD SHEATHING PER STRUCT. ENG. - 2X6 WOOD DECKING - ROOF RAFTERS

### **FLOOR TYPES:**

- FI SLAB-ON-GRAD FLOOR ASSEMBLY:
   FLOOR FINISH - SLAB-ON-GRADE PER STRUCT.
  - 6 MIL POLY V.B. RIO RIGID INSULATION
- 3/4" PLYWOOD SHEATHING - FLOOR JOIST PER STRUCT. ENG.
  - 45 MIN. FIRE SEPARATION (BCBC ACCUMULATIVE METHOD)

- COMPACTED SOIL
- F2 FLOOR ASSEMBLY (TYP.):
   FLOOR FINISH
  - 5/8" TYPE 'X' GYPSUM BOARD

DEC 15/17 ISSUED FOR INAC NOV 22/17 ISSUED FOR REVIEW REMARKS DRAWING REVISIONS / ISSUES

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Scott M. Kemp Architect

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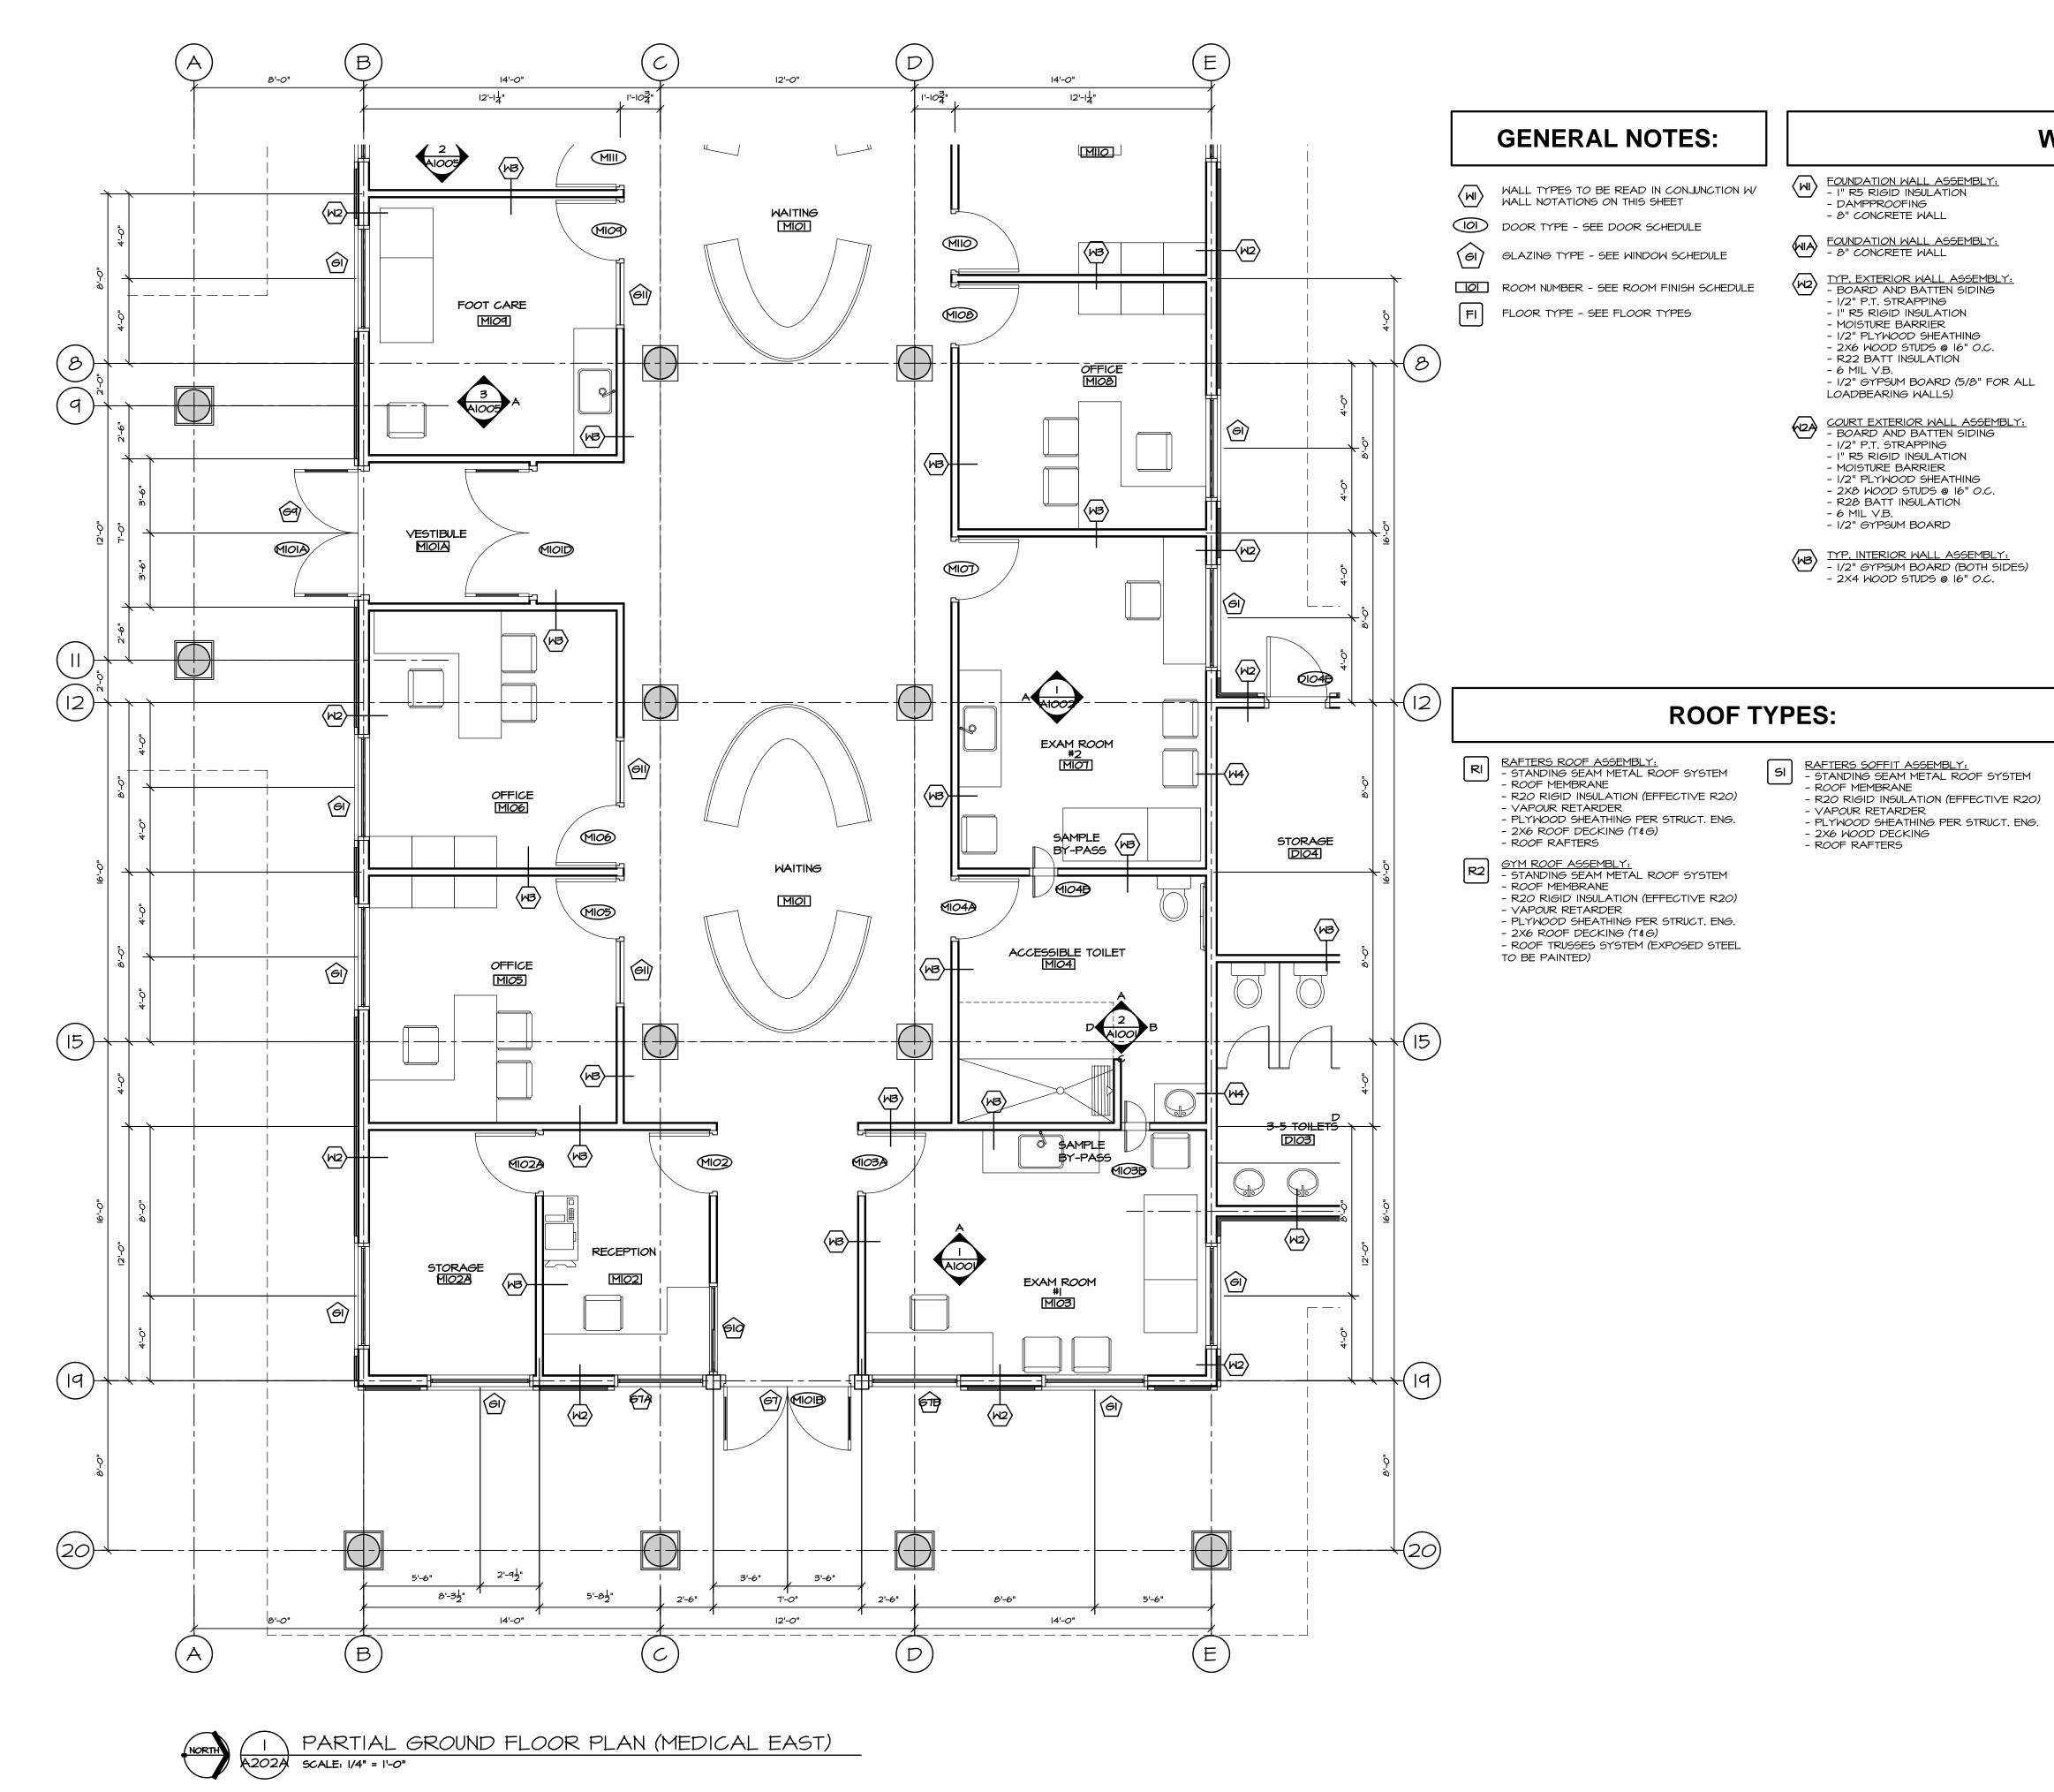
PROJECT

MALAHAT MULTIPURPOSE CULTURAL CENTRE

Malahat, BC

DRAWING TITLE PARTIAL GROUND FLOOR PLAN (MEDICAL WEST)

DATE MAR./17 CHK'D SK JOB No. DESIGN CHK'D \_ A202A



### **WALL TYPES:**

- ----
- COURT INTERIOR WALL ASSEMBLY:
   1/2" GYPSUM BOARD (BOTH SIDES)
   2X8 WOOD STUDS @ 16" O.C.
- | INTERIOR WALL ASSEMBLY:
   1/2" TYPE 'X' GYPSUM BOARD (BOTH SIDES)
   2X6 WOOD STUDS @ 16" O.C.
- L HOUR F.R.R. INTERIOR WALL ASSEMBLY ULC #W310:
- 5/8" TYPE 'X' GYPSUM BOARD (BOTH SIDES)
   2X4 MOOD STUDS @ 16" O.C.
   FIRE RETARDANT PLYMOOD AS REQUIRED
  FOR EQUIPMENT SUPPORT ON WALL
- LHOUR F.R.R. INTERIOR WALL ASSEMBLY
  ULC #W310:
   5/8" TYPE 'X' GYPSUM BOARD (BOTH SIDES)
   2X8 WOOD STUDS @ 16" O.C.
   FIRE RETARDANT PLYWOOD AS REQUIRED
  FOR EQUIPMENT SUPPORT ON WALL
- ALL LOADBEARING WALLS, POSTS, COLUMNS & SUPPORTS TO HAVE 45 MIN. F.R.R. - USE 5/8" TYPE 'X' GWB IN-LIEU OF 1/2" GWB

### **FLOOR TYPES:**

- FI SLAB-ON-GRAD FLOOR ASSEMBLY:
   FLOOR FINISH
   SLAB-ON-GRADE PER STRUCT.
   6 MIL POLY V.B.
   RIO RIGID INSULATION
- F2 FLOOR ASSEMBLY (TYP.):
   FLOOR FINISH

- COMPACTED SOIL

- FLOOR FINISH
- 3/4" PLYWOOD SHEATHING
- FLOOR JOIST PER STRUCT. ENG.
- 5/8" TYPE 'X' GYPSUM BOARD

45 MIN. FIRE SEPARATION (BCBC ACCUMULATIVE METHOD)

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NOV 22/17	ISSUED FOR REVIEW	_		
DATE	REMARKS	NO.		
DRAWING REVISIONS / ISSUES				

Scott M. Kemp Architect

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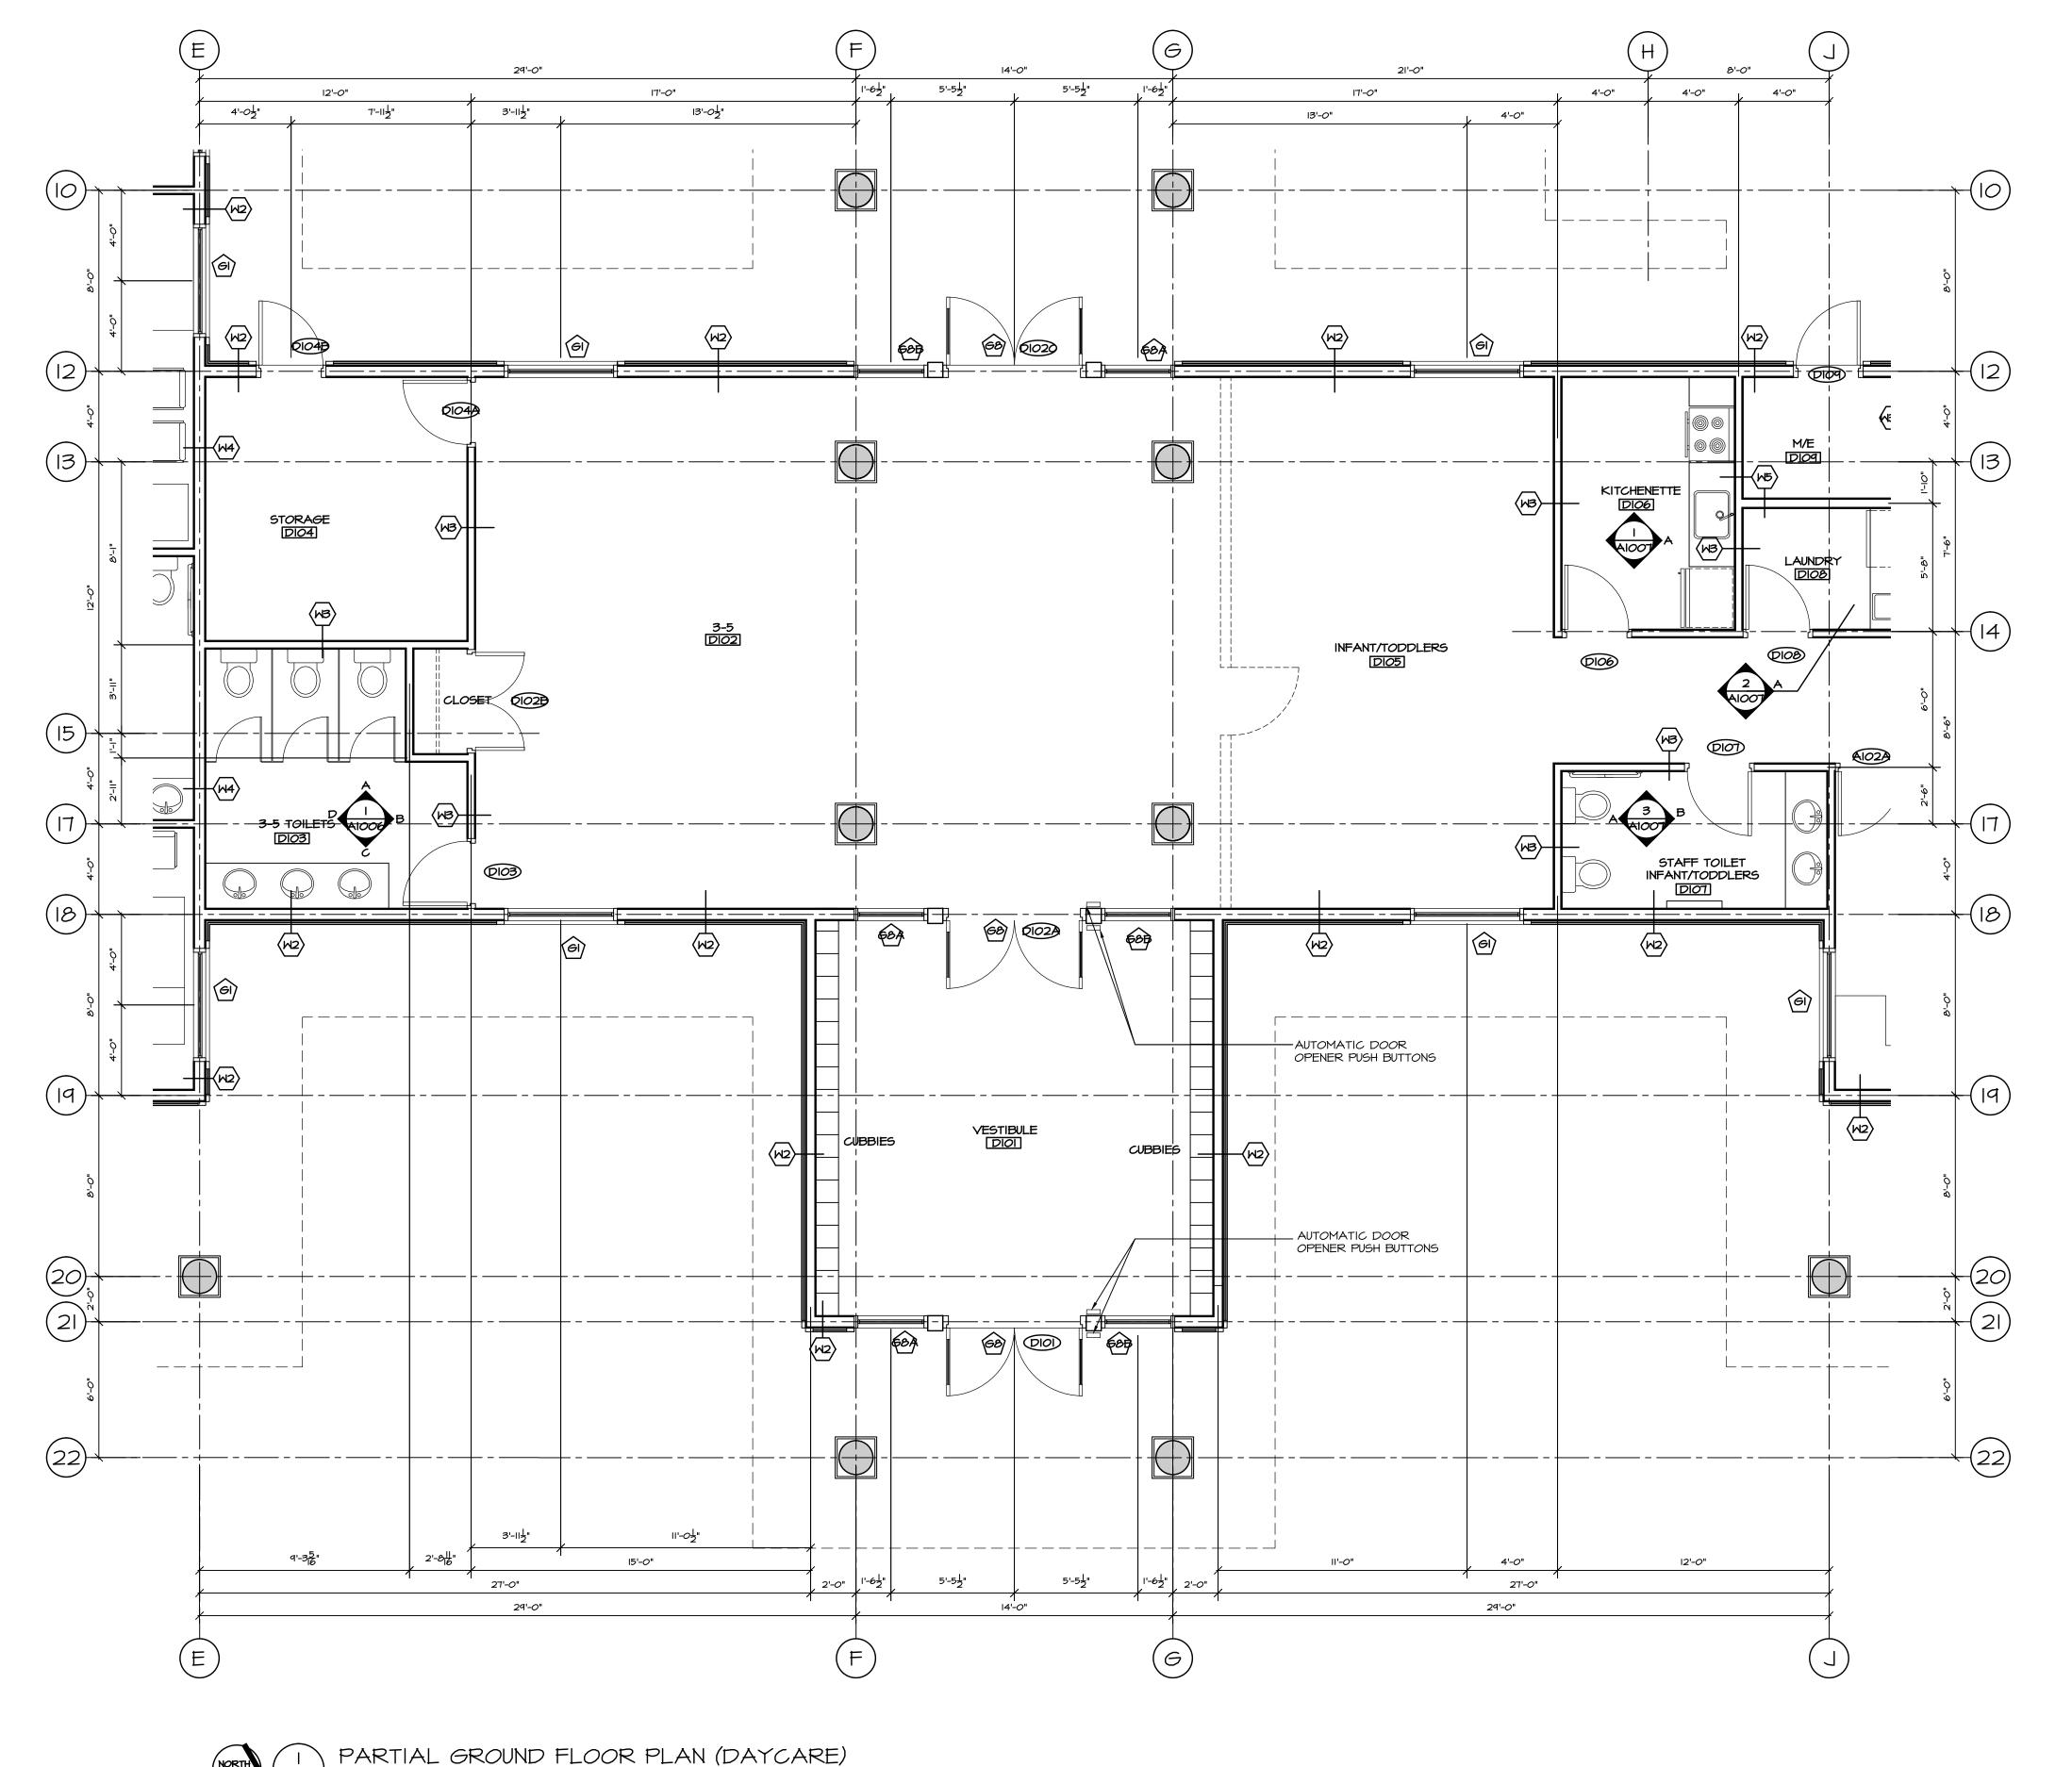
PROJECT

MALAHAT MULTIPURPOSE CULTURAL CENTRE

Malahat, BC

PARTIAL GROUND FLOOR PLAN (MEDICAL EAST)

DRA	MN ML	DATE MAR./I7
CHK'	D SK	JOB No
DESI	<i>G</i> N	DRAWING No.
CHK'	D _	□ A202B
SCAL	LE AS SHOWN	



- WALL TYPES TO BE READ IN CONJUNCTION W/ WALL NOTATIONS ON THIS SHEET
- DOOR TYPE SEE DOOR SCHEDULE
  - GLAZING TYPE SEE WINDOW SCHEDULE
- IOI ROOM NUMBER SEE ROOM FINISH SCHEDULE
- FLOOR TYPE SEE FLOOR TYPES

### **WALL TYPES:**

- FOUNDATION WALL ASSEMBLY:
   I" R5 RIGID INSULATION - DAMPPROOFING
- TYP. EXTERIOR WALL ASSEMBLY:
   BOARD AND BATTEN SIDING - I/2" P.T. STRAPPING
  - MOISTURE BARRIER - 1/2" PLYWOOD SHEATHING - 2X6 WOOD STUDS @ 16" O.C.
  - R22 BATT INSULATION - 1/2" GYPSUM BOARD (5/8" FOR ALL LOADBEARING WALLS)
- COURT EXTERIOR WALL ASSEMBLY:
   BOARD AND BATTEN SIDING - I/2" P.T. STRAPPING
- MOISTURE BARRIER - 1/2" PLYWOOD SHEATHING - R28 BATT INSULATION

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- 8" CONCRETE WALL
- FOUNDATION WALL ASSEMBLY:
   8" CONCRETE WALL
- I" R5 RIGID INSULATION
- 6 MIL V.B.
- I" R5 RIGID INSULATION
- 2X8 WOOD STUDS @ 16" O.C. - 6 MIL V.B. - 1/2" GYPSUM BOARD
- TYP. INTERIOR WALL ASSEMBLY:
   I/2" GYPSUM BOARD (BOTH SIDE - I/2" GYPSUM BOARD (BOTH SIDES) - 2X4 WOOD STUDS @ 16" O.C.

- COURT INTERIOR WALL ASSEMBLY:
   1/2" GYPSUM BOARD (BOTH SIDES)
- | INTERIOR WALL ASSEMBLY: 1/2" TYPE 'X' GYPSUM BOA - I/2" TYPE 'X' GYPSUM BOARD (BOTH SIDES) - 2X6 WOOD STUDS @ 16" O.C.

- 2X8 WOOD STUDS @ 16" O.C.

- LHOUR F.R.R. INTERIOR WALL ASSEMBLY ULC #W310: - 5/8" TYPE 'X' GYPSUM BOARD (BOTH SIDES) - 2X4 WOOD STUDS @ 16" O.C. - FIRE RETARDANT PLYWOOD AS REQUIRED FOR EQUIPMENT SUPPORT ON WALL
- L HOUR F.R.R. INTERIOR WALL ASSEMBLY ULC #W310: <u>ULC #M310:</u> - 5/8" TYPE 'X' GYPSUM BOARD (BOTH SIDES) - 2X8 WOOD STUDS @ 16" O.C. - FIRE RETARDANT PLYWOOD AS REQUIRED FOR EQUIPMENT SUPPORT ON WALL
- ALL LOADBEARING WALLS, POSTS, COLUMNS & SUPPORTS TO HAVE 45 MIN. F.R.R. - USE 5/8" TYPE 'X' GWB IN-LIEU OF 1/2" *G*MB

### **ROOF TYPES:**

- <u>RAFTERS ROOF ASSEMBLY:</u>
   STANDING SEAM METAL ROOF SYSTEM ROOF MEMBRANE
- R20 RIGID INSULATION (EFFECTIVE R20) - VAPOUR RETARDER - PLYWOOD SHEATHING PER STRUCT. ENG. - 2X6 ROOF DECKING (T&G) - ROOF RAFTERS
- <u>GYM ROOF ASSEMBLY:</u> STANDING SEAM METAL ROOF SYSTEM
- ROOF MEMBRANE - R20 RIGID INSULATION (EFFECTIVE R20) - VAPOUR RETARDER
- PLYWOOD SHEATHING PER STRUCT. ENG. - 2X6 ROOF DECKING (T&G) - ROOF TRUSSES SYSTEM (EXPOSED STEEL TO BE PAINTED)
- RAFTERS SOFFIT ASSEMBLY: STANDING SEAM METAL ROOF SYSTEM - ROOF MEMBRANE - R20 RIGID INSULATION (EFFECTIVE R20)
- VAPOUR RETARDER - PLYWOOD SHEATHING PER STRUCT. ENG. - 2X6 WOOD DECKING - ROOF RAFTERS

### **FLOOR TYPES:**

- FI SLAB-ON-GRAD FLOOR ASSEMBLY: FLOOR FINISH
- SLAB-ON-GRADE PER STRUCT. - 6 MIL POLY V.B. - RIO RIGID INSULATION - COMPACTED SOIL
- F2 FLOOR ASSEMBLY (TYP.):
   FLOOR FINISH
  - 3/4" PLYWOOD SHEATHING
  - FLOOR JOIST PER STRUCT. ENG. - 5/8" TYPE 'X' GYPSUM BOARD

45 MIN. FIRE SEPARATION (BCBC ACCUMULATIVE METHOD)

DEC 15/17	ISSUED FOR INAC	<u>_</u>
NOY 22/17	ISSUED FOR REVIEW	<u>_</u>
DATE	REMARKS	NO.

Scott M. Kemp Architect

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PROJECT


DRAWING REVISIONS / ISSUES

MALAHAT MULTIPURPOSE CULTURAL CENTRE

Malahat, BC

DRAWING TITLE PARTIAL GROUND FLOOR PLAN (DAYCARE)

DATE MAR./17 CHK'D SK JOB No. DESIGN DRAWING No. A202C CHK'D \_ SCALE AS SHOWN

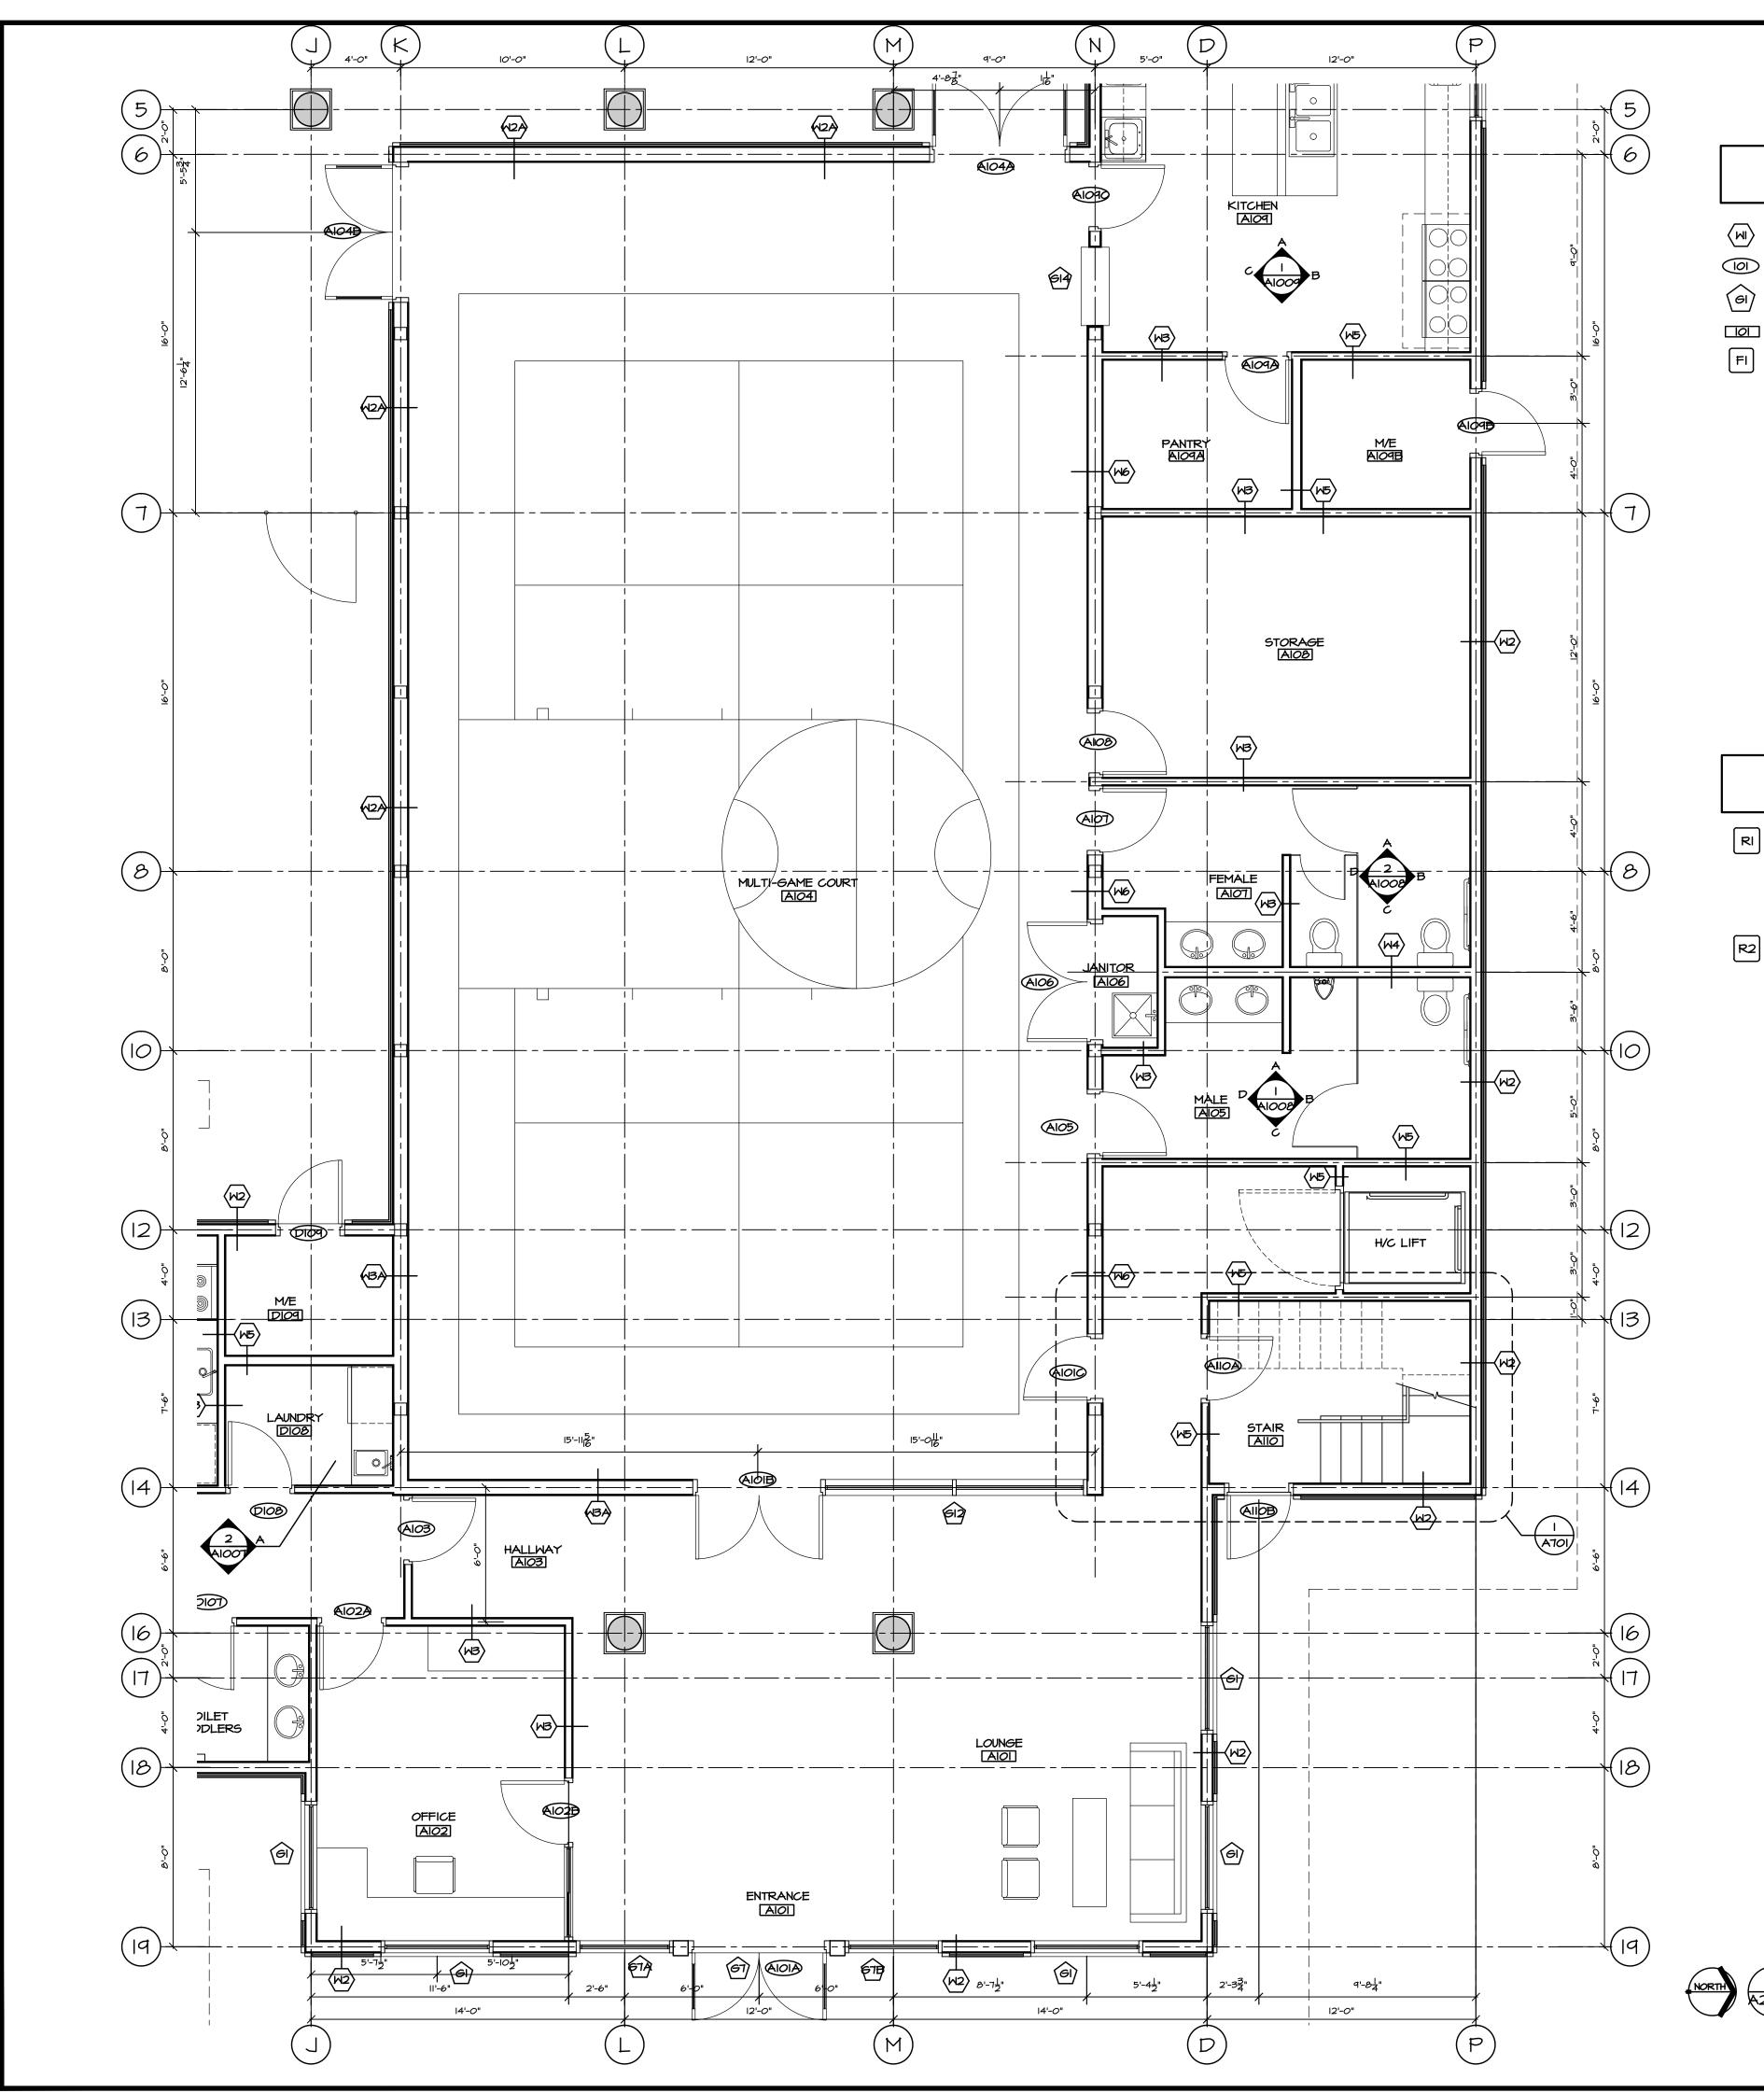

- WALL TYPES TO BE READ IN CONJUNCTION W WALL NOTATIONS ON THIS SHEET
- DOOR TYPE SEE DOOR SCHEDULE
- (61) GLAZING TYPE SEE WINDOW SCHEDULE
- ROOM NUMBER SEE ROOM FINISH SCHEDULE
- FI FLOOR TYPE SEE FLOOR TYPES

### **WALL TYPES:**

- FOUNDATION WALL ASSEMBLY:
   I" R5 RIGID INSULATION - DAMPPROOFING - 8" CONCRETE WALL
- FOUNDATION WALL ASSEMBLY:
   8" CONCRETE WALL
- TYP. EXTERIOR WALL ASSEMBLY:
   BOARD AND BATTEN SIDING
- I/2" P.T. STRAPPING - I" R5 RIGID INSULATION - MOISTURE BARRIER - 1/2" PLYWOOD SHEATHING
- 2X6 WOOD STUDS @ 16" O.C. - R22 BATT INSULATION - 6 MIL V.B. - 1/2" GYPSUM BOARD (5/8" FOR ALL LOADBEARING WALLS)
- COURT EXTERIOR WALL ASSEMBLY:
   BOARD AND BATTEN SIDING
- I/2" P.T. STRAPPING - I" R5 RIGID INSULATION - MOISTURE BARRIER - 1/2" PLYWOOD SHEATHING
- 2X8 WOOD STUDS @ 16" O.C. - R28 BATT INSULATION - 6 MIL V.B. - 1/2" GYPSUM BOARD
- TYP. INTERIOR WALL ASSEMBLY:
   1/2" GYPSUM BOARD (BOTH SIDES)
   2X4 WOOD STUDS @ 16" O.C.

RAFTERS SOFFIT ASSEMBLY:
- STANDING SEAM METAL ROOF SYSTEM

- R20 RIGID INSULATION (EFFECTIVE R20)

- PLYWOOD SHEATHING PER STRUCT. ENG.

- ROOF MEMBRANE

- VAPOUR RETARDER

- 2X6 WOOD DECKING

- COURT INTERIOR WALL ASSEMBLY:
   1/2" GYPSUM BOARD (BOTH SIDES)
   2X8 WOOD STUDS @ 16" O.C.
- W4 INTERIOR WALL ASSEMBLY:
   I/2" TYPE 'X' GYPSUM BOAR
- 2X6 WOOD STUDS @ 16" O.C.

- I/2" TYPE 'X' GYPSUM BOARD (BOTH SIDES)

- L HOUR F.R.R. INTERIOR WALL ASSEMBLY ULC #W310: - 5/8" TYPE 'X' GYPSUM BOARD (BOTH SIDES) - 2X4 WOOD STUDS @ 16" O.C. - FIRE RETARDANT PLYWOOD AS REQUIRED FOR EQUIPMENT SUPPORT ON WALL
- L HOUR F.R.R. INTERIOR WALL ASSEMBLY ULC #W310: - 5/8" TYPE 'X' GYPSUM BOARD (BOTH SIDES) - 2X8 WOOD STUDS @ 16" O.C. - FIRE RETARDANT PLYWOOD AS REQUIRED FOR EQUIPMENT SUPPORT ON WALL

ALL LOADBEARING WALLS, POSTS, COLUMNS & SUPPORTS TO HAVE 45 MIN. F.R.R. - USE 5/8" TYPE 'X' GWB IN-LIEU OF 1/2" *G*WB

### **ROOF TYPES:**

- RAFTERS ROOF ASSEMBLY: - STANDING SEAM METAL ROOF SYSTEM ROOF MEMBRANE - R20 RIGID INSULATION (EFFECTIVE R20)
- VAPOUR RETARDER - PLYWOOD SHEATHING PER STRUCT. ENG. - 2X6 ROOF DECKING (T&G) - ROOF RAFTERS
- <u>GYM ROOF ASSEMBLY:</u> STANDING SEAM METAL ROOF SYSTEM - ROOF MEMBRANE - R20 RIGID INSULATION (EFFECTIVE R20) - VAPOUR RETARDER
- PLYWOOD SHEATHING PER STRUCT. ENG. - 2X6 ROOF DECKING (T&G) - ROOF TRUSSES SYSTEM (EXPOSED STEEL TO BE PAINTED)

### **FLOOR TYPES:**

- FI SLAB-ON-GRAD FLOOR ASSEMBLY:
   FLOOR FINISH - SLAB-ON-GRADE PER STRUCT.
- 6 MIL POLY V.B. RIO RIGID INSULATION - COMPACTED SOIL
- F2 FLOOR ASSEMBLY (TYP.):
   FLOOR FINISH - 3/4" PLYWOOD SHEATHING - FLOOR JOIST PER STRUCT. ENG. - 5/8" TYPE 'X' GYPSUM BOARD 45 MIN. FIRE SEPARATION (BCBC ACCUMULATIVE METHOD)

DEC ISSUED FOR INAC NOV 22/17 ISSUED FOR REVIEW REMARKS DRAWING REVISIONS / ISSUES

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PROJECT

**MALAHAT** MULTIPURPOSE CULTURAL CENTRE


Malahat, BC

PARTIAL GROUND FLOOR PLAN (ASSEMBLY EAST)

DATE MAR./17 CHK'D SK JOB No. DESIGN CHK'D \_



PARTIAL GROUND FLOOR PLAN (ASSEMBLY EAST) SCALE: 1/4" = 1'-0"

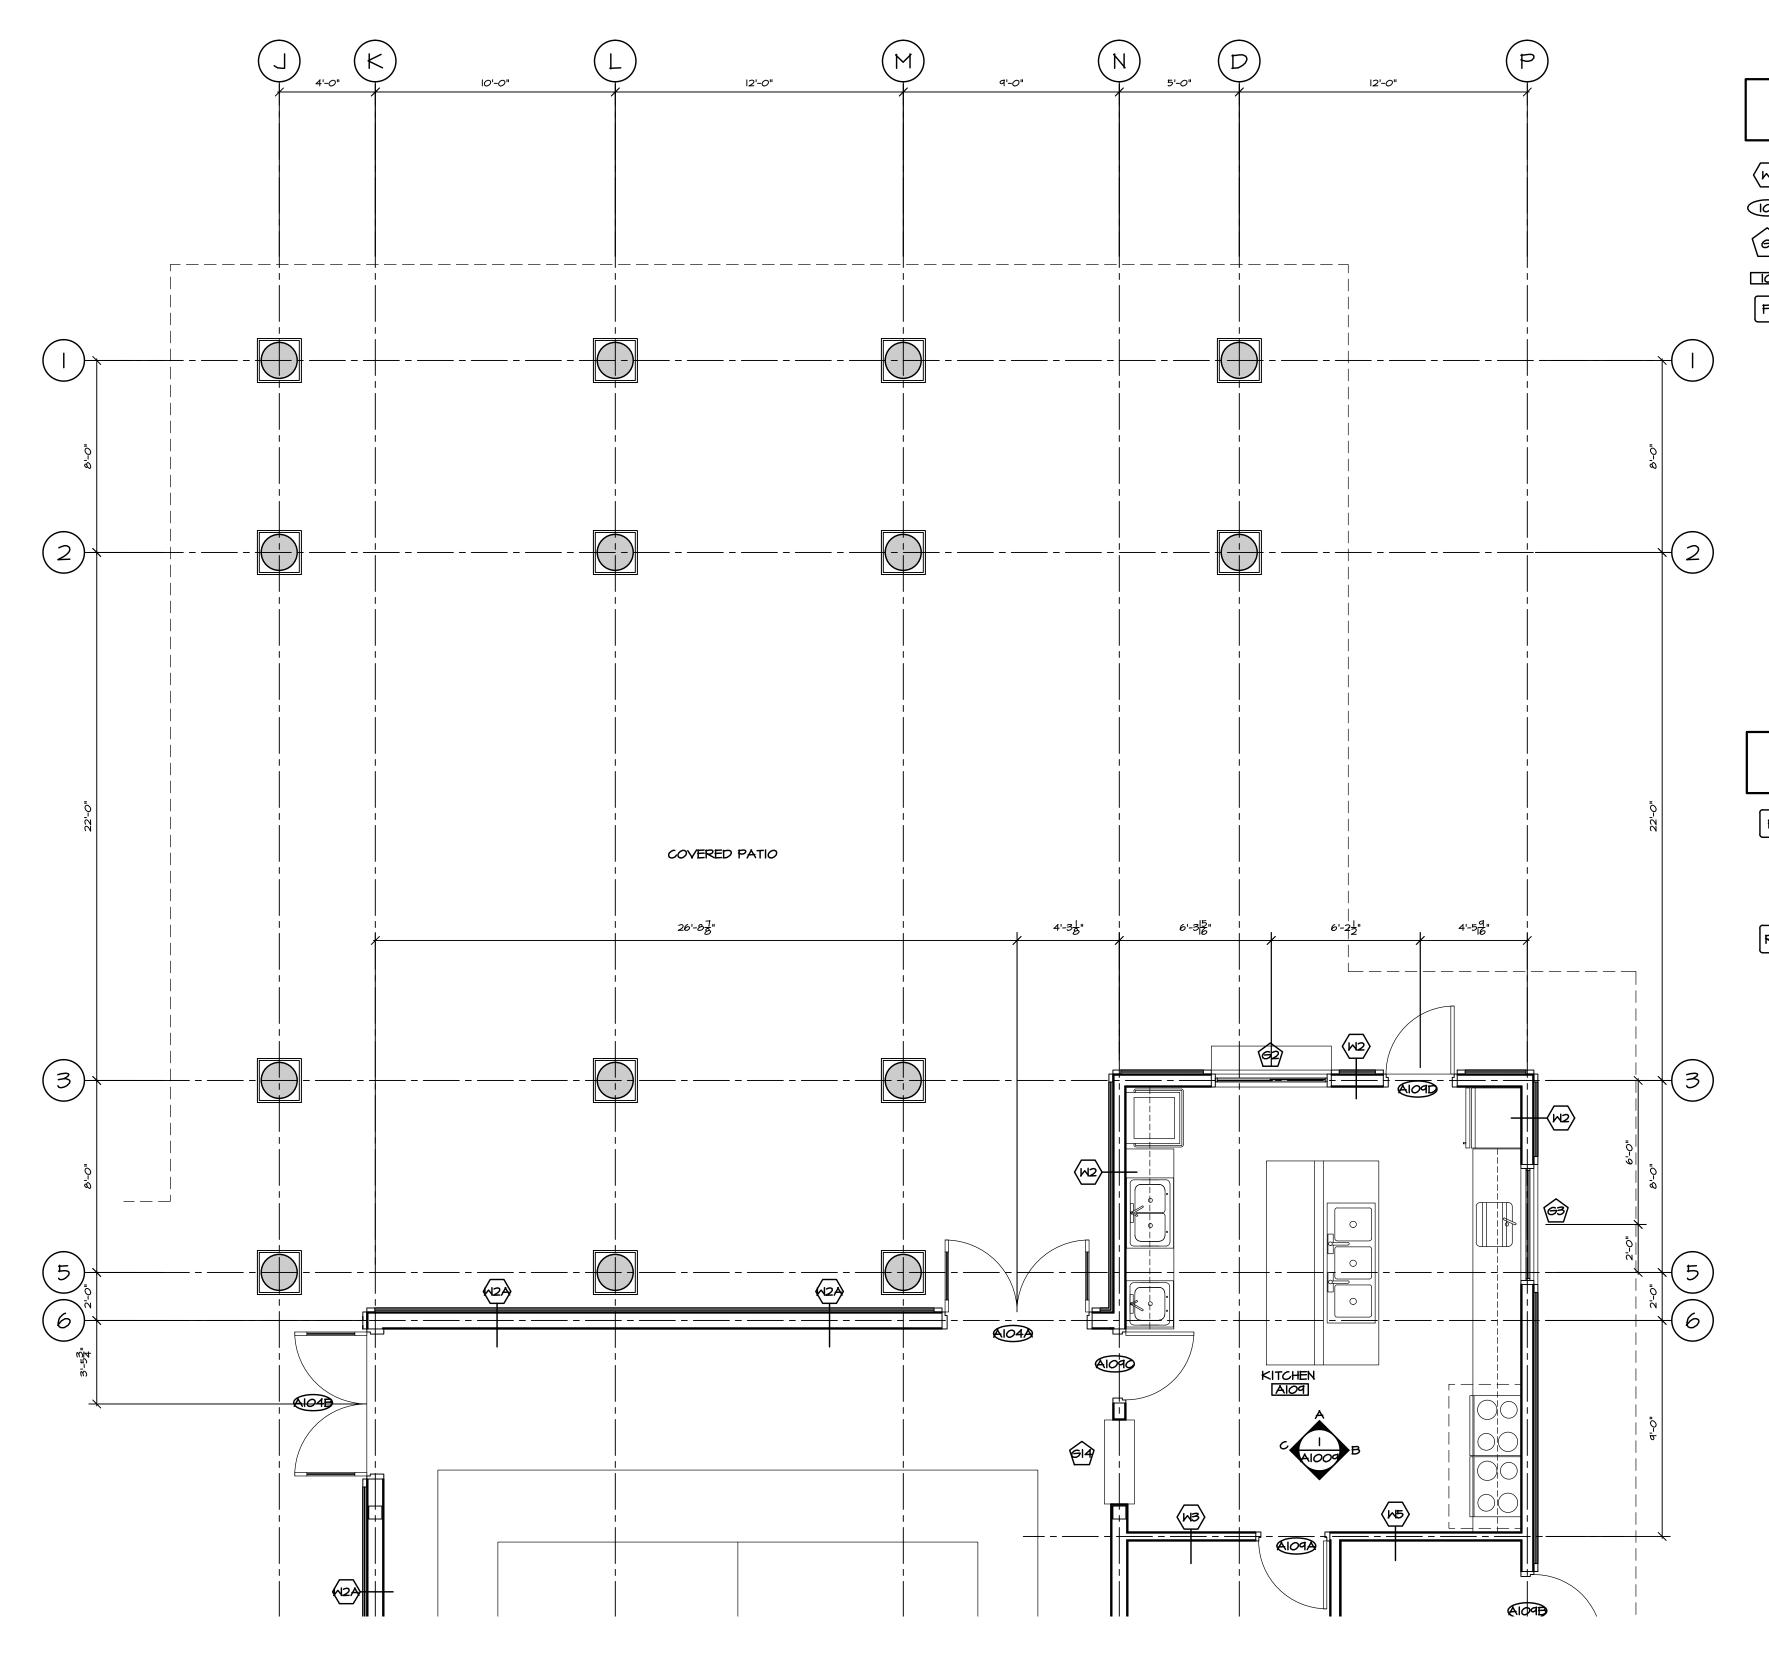

- WALL TYPES TO BE READ IN CONJUNCTION W WALL NOTATIONS ON THIS SHEET
- DOOR TYPE SEE DOOR SCHEDULE
- GLAZING TYPE SEE WINDOW SCHEDULE
- IOI ROOM NUMBER SEE ROOM FINISH SCHEDULE
- FLOOR TYPE SEE FLOOR TYPES

### **WALL TYPES:**

- FOUNDATION WALL ASSEMBLY:
   I" R5 RIGID INSULATION
   DAMPPROOFING - 8" CONCRETE WALL
- FOUNDATION WALL ASSEMBLY:
   8" CONCRETE WALL
- TYP. EXTERIOR WALL ASSEMBLY:
   BOARD AND BATTEN SIDING
- I/2" P.T. STRAPPING - I" R5 RIGID INSULATION - MOISTURE BARRIER - 1/2" PLYWOOD SHEATHING

- 2X6 WOOD STUDS @ 16" O.C.

- R22 BATT INSULATION - 6 MIL V.B. - 1/2" GYPSUM BOARD (5/8" FOR ALL LOADBEARING WALLS)
- COURT EXTERIOR WALL ASSEMBLY:
   BOARD AND BATTEN SIDING
   I/2" P.T. STRAPPING
  - I" R5 RIGID INSULATION - MOISTURE BARRIER - 1/2" PLYWOOD SHEATHING - 2X8 WOOD STUDS @ 16" O.C. - R28 BATT INSULATION

- 6 MIL V.B.

TYP. INTERIOR WALL ASSEMBLY:
- 1/2" GYPSUM BOARD (BOTH SIDES) - 2X4 WOOD STUDS @ 16" O.C.

- 1/2" GYPSUM BOARD

- COURT INTERIOR WALL ASSEMBLY:
   1/2" GYPSUM BOARD (BOTH SIDES) - 2X8 WOOD STUDS @ 16" O.C.
- W4 INTERIOR WALL ASSEMBLY:
   I/2" TYPE 'X' GYPSUM BOAI - I/2" TYPE 'X' GYPSUM BOARD (BOTH SIDES) - 2X6 WOOD STUDS @ 16" O.C.
- WES LHOUR F.R.R. INTERIOR WALL ASSEMBLY ULC #W310: - 5/8" TYPE 'X' GYPSUM BOARD (BOTH SIDES) - 2X4 WOOD STUDS @ 16" O.C. - FIRE RETARDANT PLYWOOD AS REQUIRED FOR EQUIPMENT SUPPORT ON WALL
- L HOUR F.R.R. INTERIOR WALL ASSEMBLY
  ULC #W310: - 5/8" TYPE 'X' GYPSUM BOARD (BOTH SIDES) - 2X8 WOOD STUDS @ 16" O.C. - FIRE RETARDANT PLYWOOD AS REQUIRED FOR EQUIPMENT SUPPORT ON WALL

ALL LOADBEARING WALLS, POSTS, COLUMNS & SUPPORTS TO HAVE 45 MIN. F.R.R. - USE 5/8" TYPE 'X' GWB IN-LIEU OF 1/2" *G*WB

### **ROOF TYPES:**

RAFTERS ROOF ASSEMBLY: - STANDING SEAM METAL ROOF SYSTEM - ROOF MEMBRANE - R20 RIGID INSULATION (EFFECTIVE R20) - VAPOUR RETARDER - PLYWOOD SHEATHING PER STRUCT. ENG. - 2X6 ROOF DECKING (T&G)

- ROOF RAFTERS

TO BE PAINTED)

- <u>GYM ROOF ASSEMBLY:</u> STANDING SEAM METAL ROOF SYSTEM - ROOF MEMBRANE - R20 RIGID INSULATION (EFFECTIVE R20)
- VAPOUR RETARDER - PLYWOOD SHEATHING PER STRUCT. ENG. - 2X6 ROOF DECKING (T&G) - ROOF TRUSSES SYSTEM (EXPOSED STEEL
- RAFTERS SOFFIT ASSEMBLY:
   STANDING SEAM METAL ROOF SYSTEM - ROOF MEMBRANE - R20 RIGID INSULATION (EFFECTIVE R20)
- VAPOUR RETARDER - PLYWOOD SHEATHING PER STRUCT. ENG. - 2X6 WOOD DECKING

### **FLOOR TYPES:**

- FI SLAB-ON-GRAD FLOOR ASSEMBLY:
   FLOOR FINISH - SLAB-ON-GRADE PER STRUCT. - 6 MIL POLY V.B. - RIO RIGID INSULATION - COMPACTED SOIL
- F2 FLOOR ASSEMBLY (TYP.):
   FLOOR FINISH
   3/4" PLYMOOD SHEATHING - 3/4" PLYWOOD SHEATHING - FLOOR JOIST PER STRUCT. ENG. - 5/8" TYPE 'X' GYPSUM BOARD 45 MIN. FIRE SEPARATION (BCBC ACCUMULATIVE METHOD)

DEC 15/17 ISSUED FOR INAC NOV 22/17 ISSUED FOR REVIEW REMARKS DRAWING REVISIONS / ISSUES

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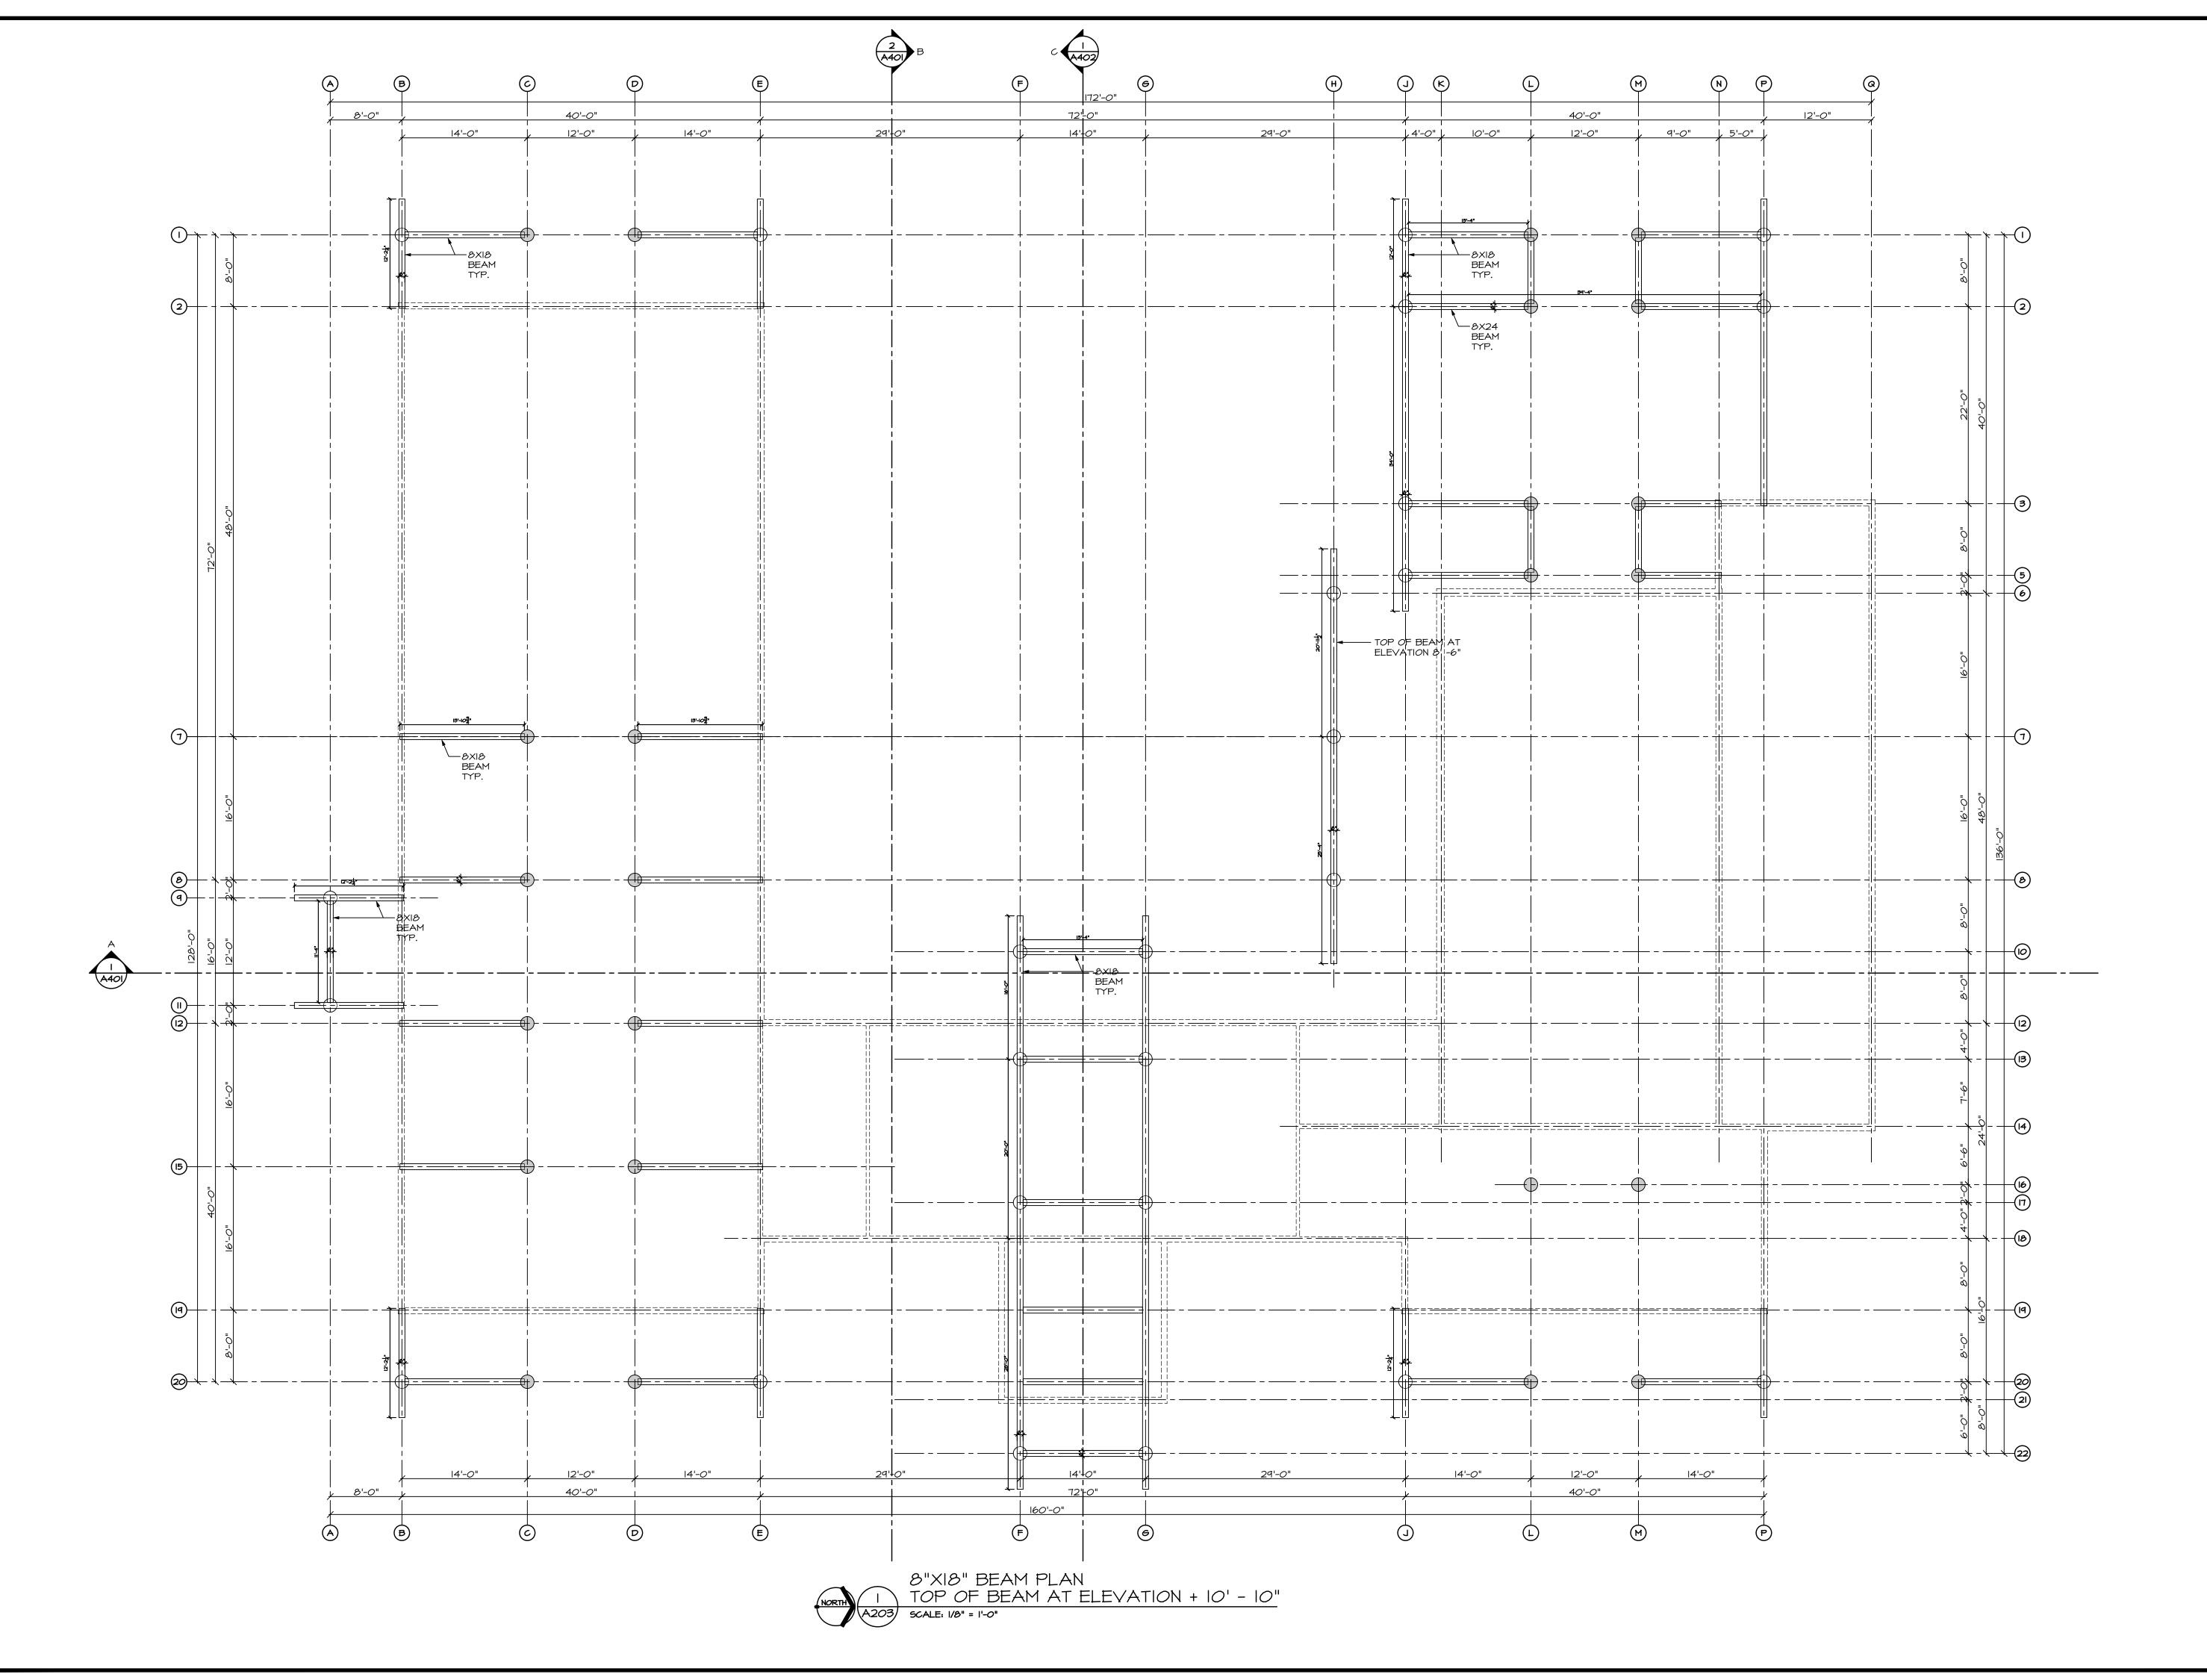
PROJECT

MALAHAT MULTIPURPOSE CULTURAL CENTRE

DRAWING TITLE PARTIAL GROUND FLOOR PLAN (ASSEMBLY WEST)

DATE MAR./17 CHK'D SK JOB No. DESIGN CHK'D \_ A202E

PARTIAL GROUND FLOOR PLAN (ASSEMBLY WEST)



Drawings shall not be scaled. The Contractor shall verify and be responsible for all dimensions, datum and elevations pertinent to executing the work. Discrepancies and variations shall be reported to the PR before work is performed. In all cases the latest version of the contract documents shall be used on site. The contractor shall ensure all previous versions are marked "Superseded" with reference to a revision number. All work shall conform to the current local Building Code, jurisdictional codes and local ordinances.

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DEC 15/17	ISSUED FOR INAC				
NOV 12/17	ISSUED FOR REVIEW	$\triangle$			
SEP.	ISSUED FOR REVIEW				
AUG. OI/IT	ISSUED FOR REVIEW				
DATE	REMARKS	NO.			
DRAWING	DRAWING REVISIONS / ISSUES				

Scott M. Kemp Architect

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PROJECT

MALAHAT MULTIPURPOSE CULTURAL CENTRE


Maiariat, DC

DRAWING TITLE

BEAM PLAN

ELEVATION + 10'-10"

DRAWN ML	-	DATE	AUG./17
CHK'D SK	(	JOB No.	-
DESIGN		DRAWING	No.
CHK'D _		A <sup>2</sup>	203
SCALE AS	SHOWN		

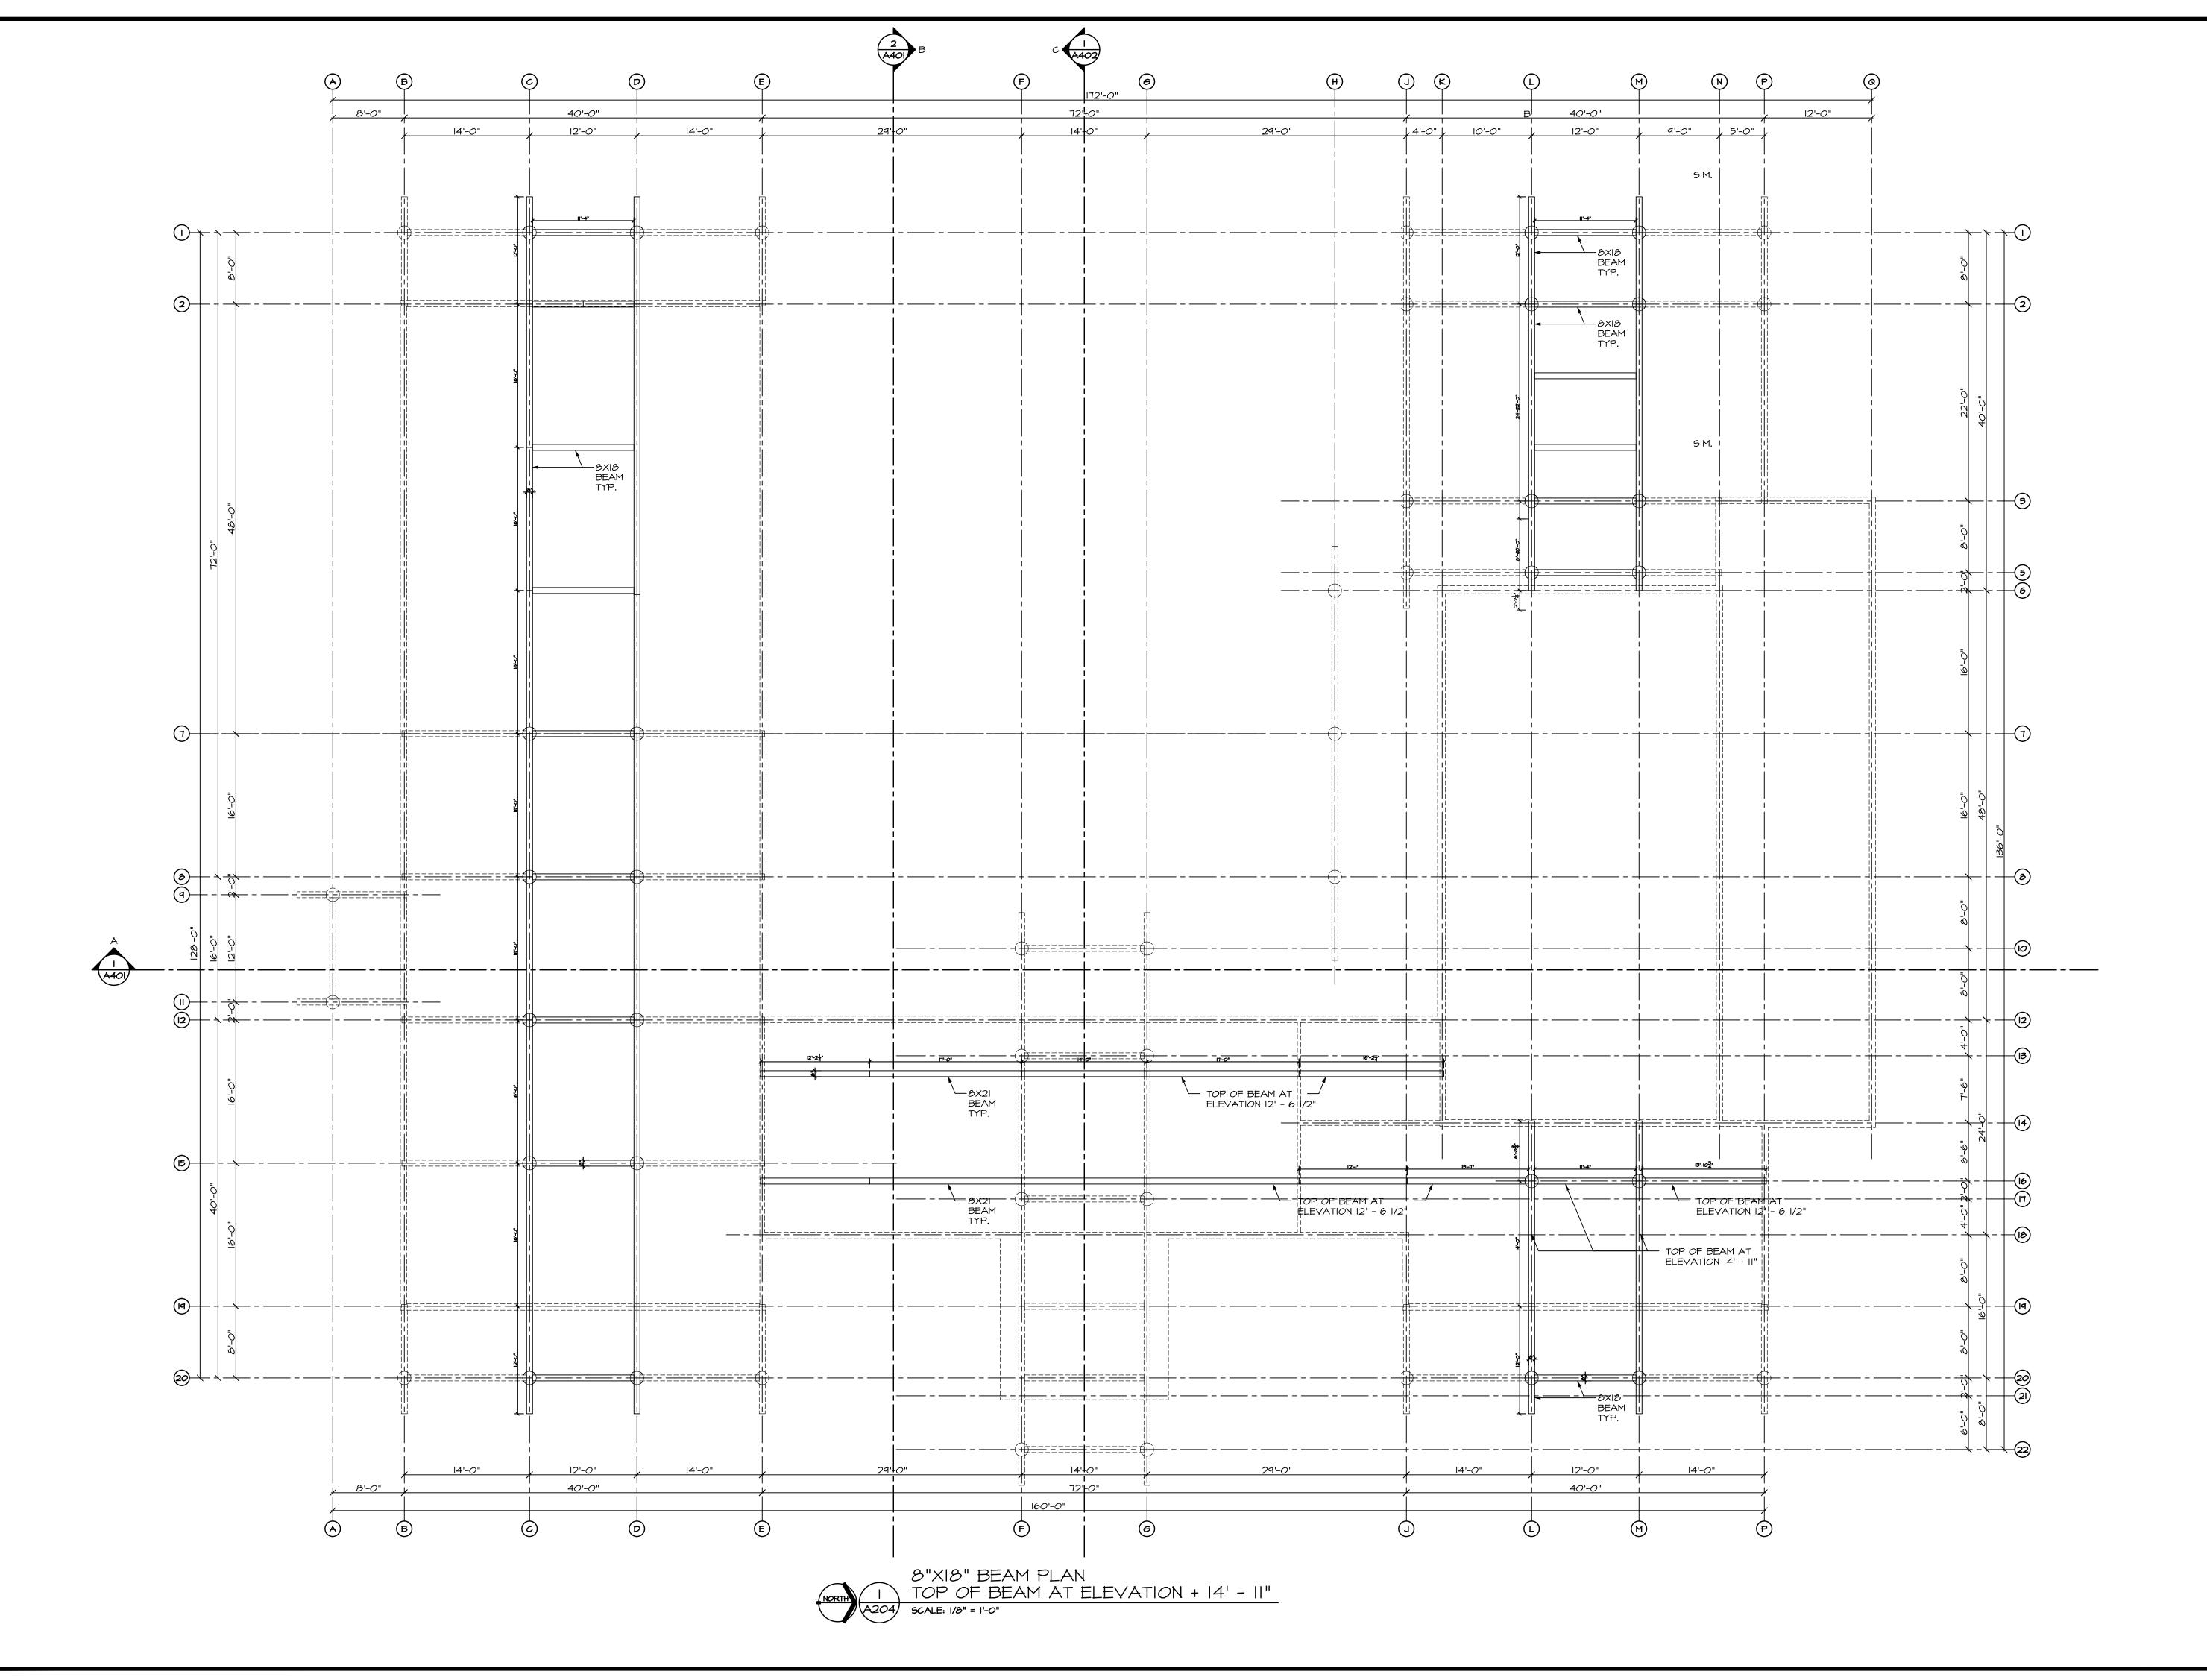

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DEC 15/17	ISSUED FOR INAC		
NOV 12/17	ISSUED FOR REVIEW	$\triangle$	
SEP.	ISSUED FOR REVIEW		
AUG. OI/IT	ISSUED FOR REVIEW		
DATE	REMARKS	NO.	
DRAWING	DRAWING REVISIONS / ISSUES		

Scott M. Kemp Architect

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PROJECT

MALAHAT MULTIPURPOSE CULTURAL CENTRE


Malahat, BC

DRAWING TITLE

BEAM PLAN

ELEVATION + 14'-11"

DRAWN ML	DATE AUG./IT
CHK'D SK	JOB No.
DESIGN	DRAWING No.
CHK'D _	A204
SCALE AS SHOWN	

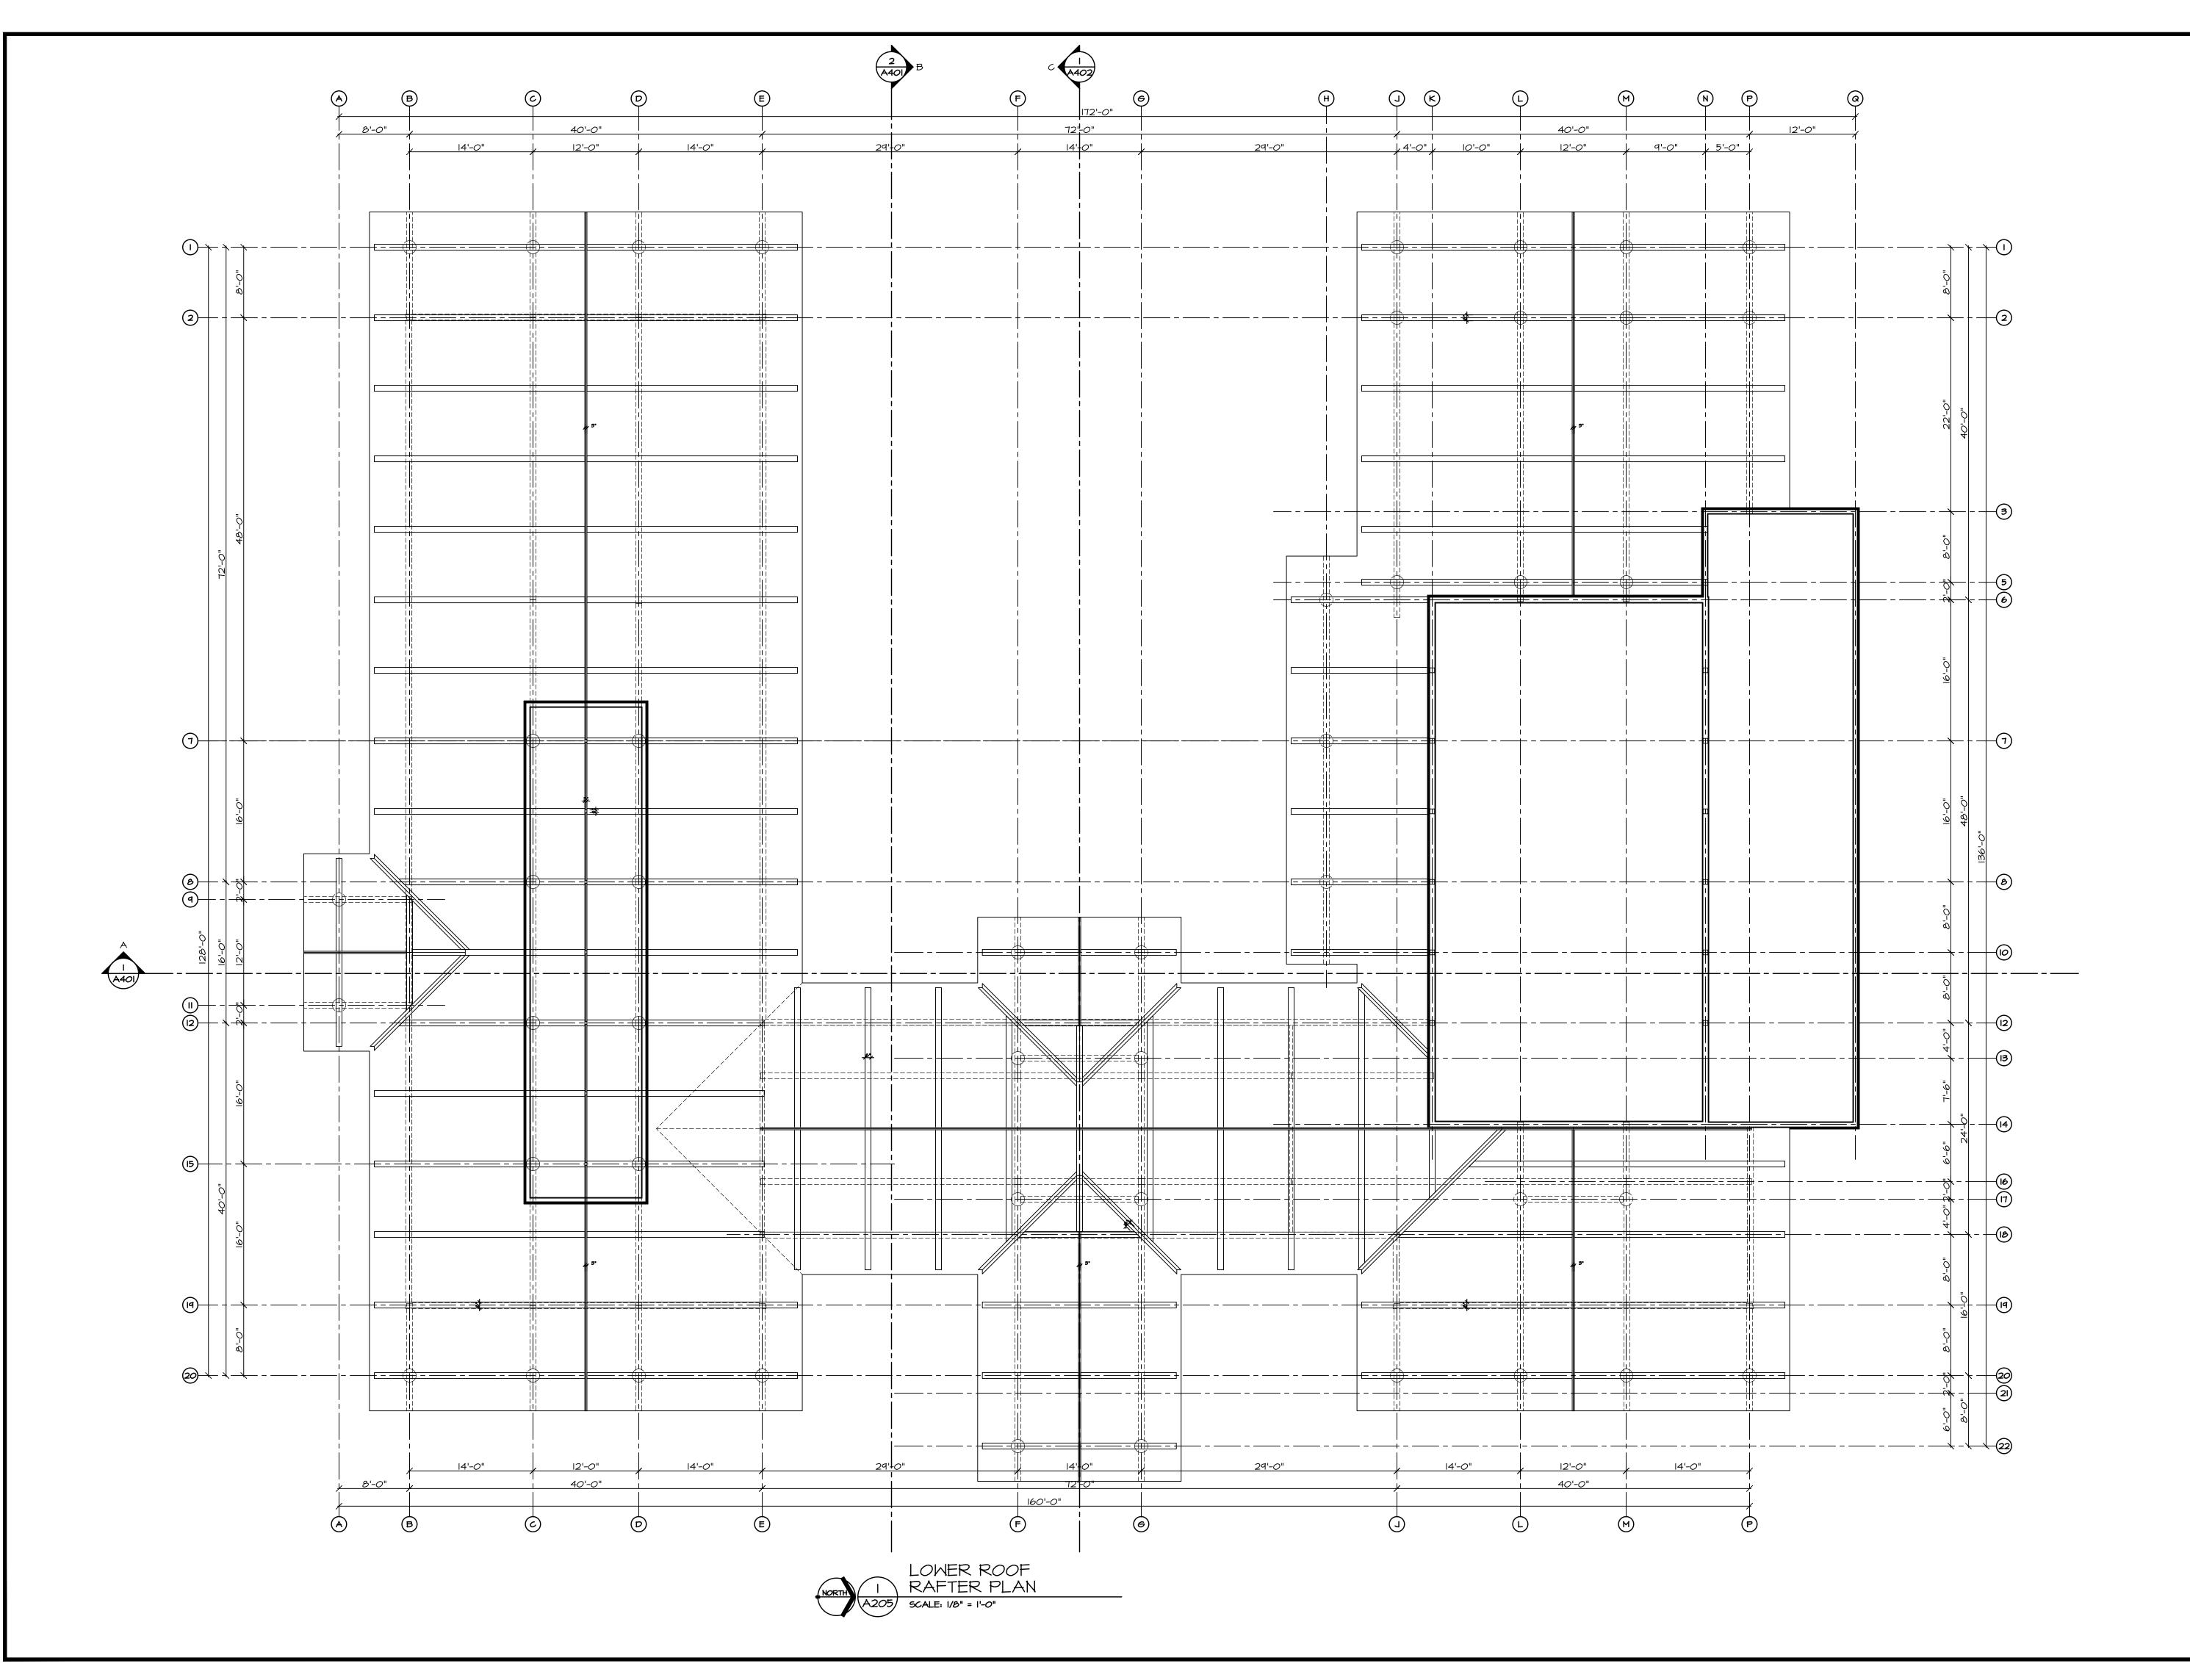

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DEC 15/17	ISSUED FOR INAC	<u>_</u>	
NOY 12/17	ISSUED FOR REVIEW	<u>_</u>	
SEP. 17/17	ISSUED FOR REVIEW	<u>_</u>	
AUG. OI/IT	ISSUED FOR REVIEW	<u>_</u>	
DATE	REMARKS	NO.	
DRAWING REVISIONS / ISSUES			

Scott M. Kemp Architect

4427 River Road West, Ladner, BC V4K 1R9 P: (604) 786-8150 F: (604) 952-6021 scott@smkarchitect.com

PROJECT

MALAHAT MULTIPURPOSE CULTURAL CENTRE


Malahat, BC


DRAWING TITLE

LOWER ROOF

RAFTER PLAN

DRAWN ML	DATE MAUG/I7
CHK'D SK	JOB No
DESIGN	DRAWING No.
CHK'D _	A205
SCALE AS SHOWN	

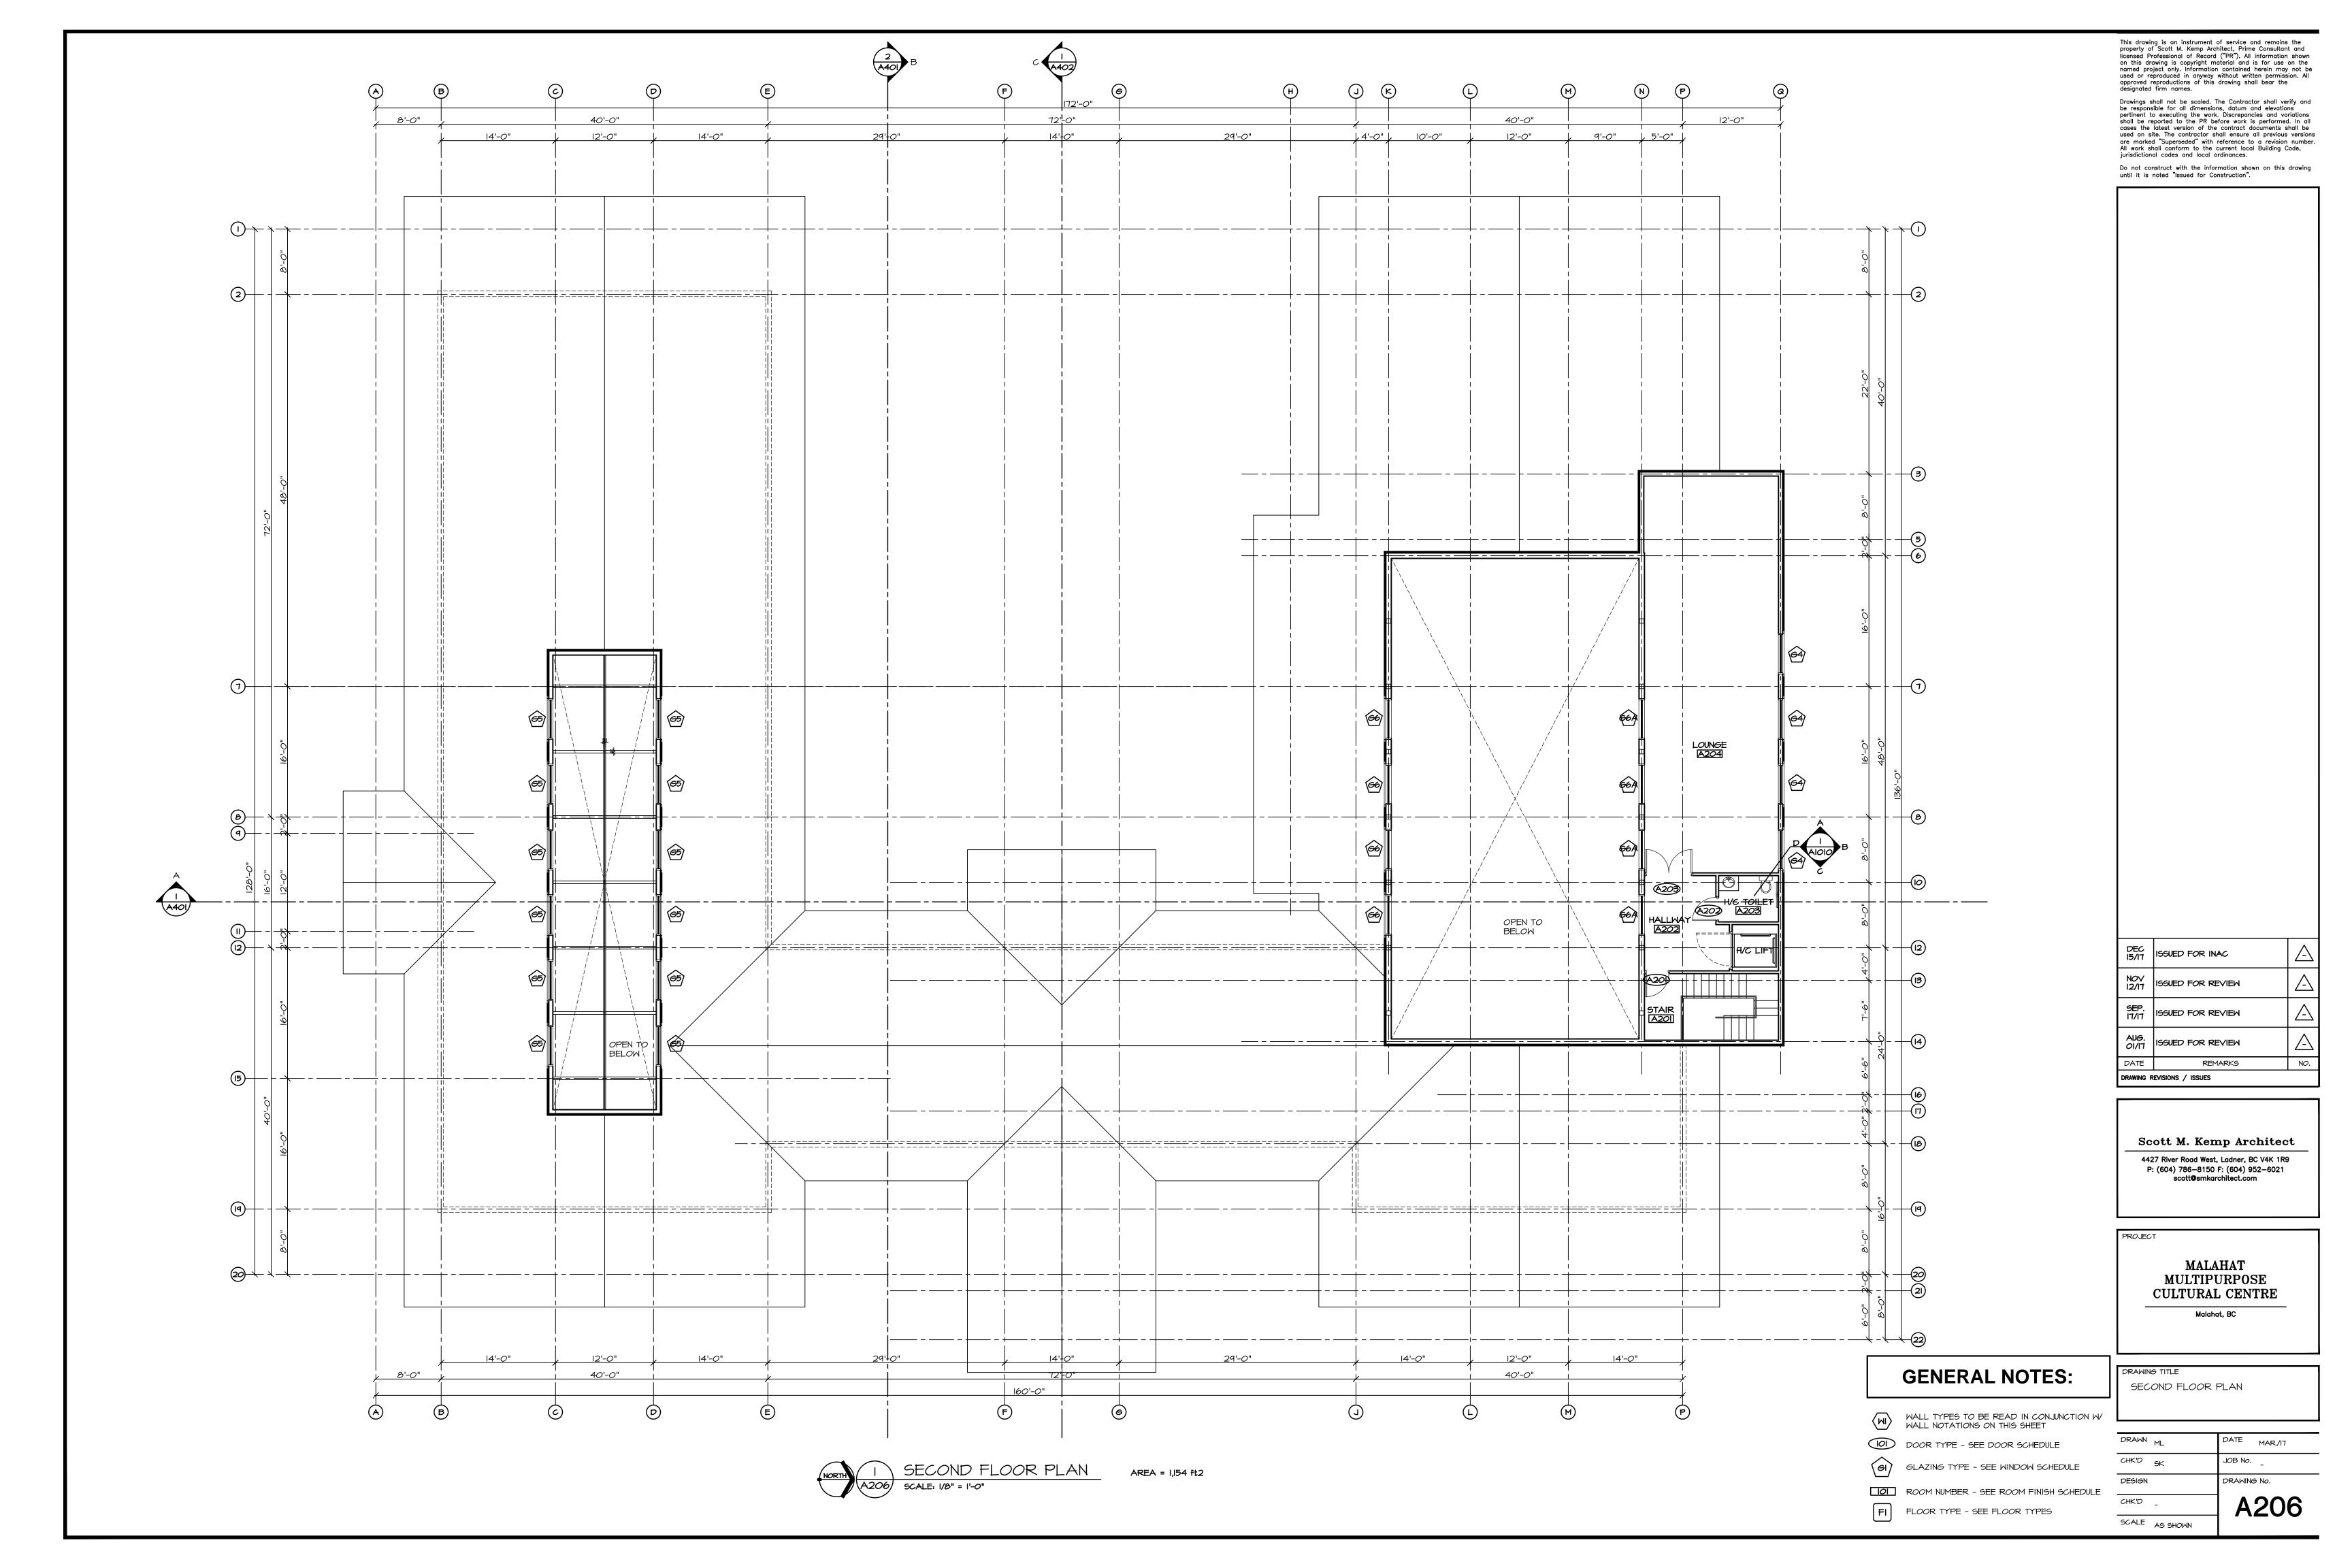

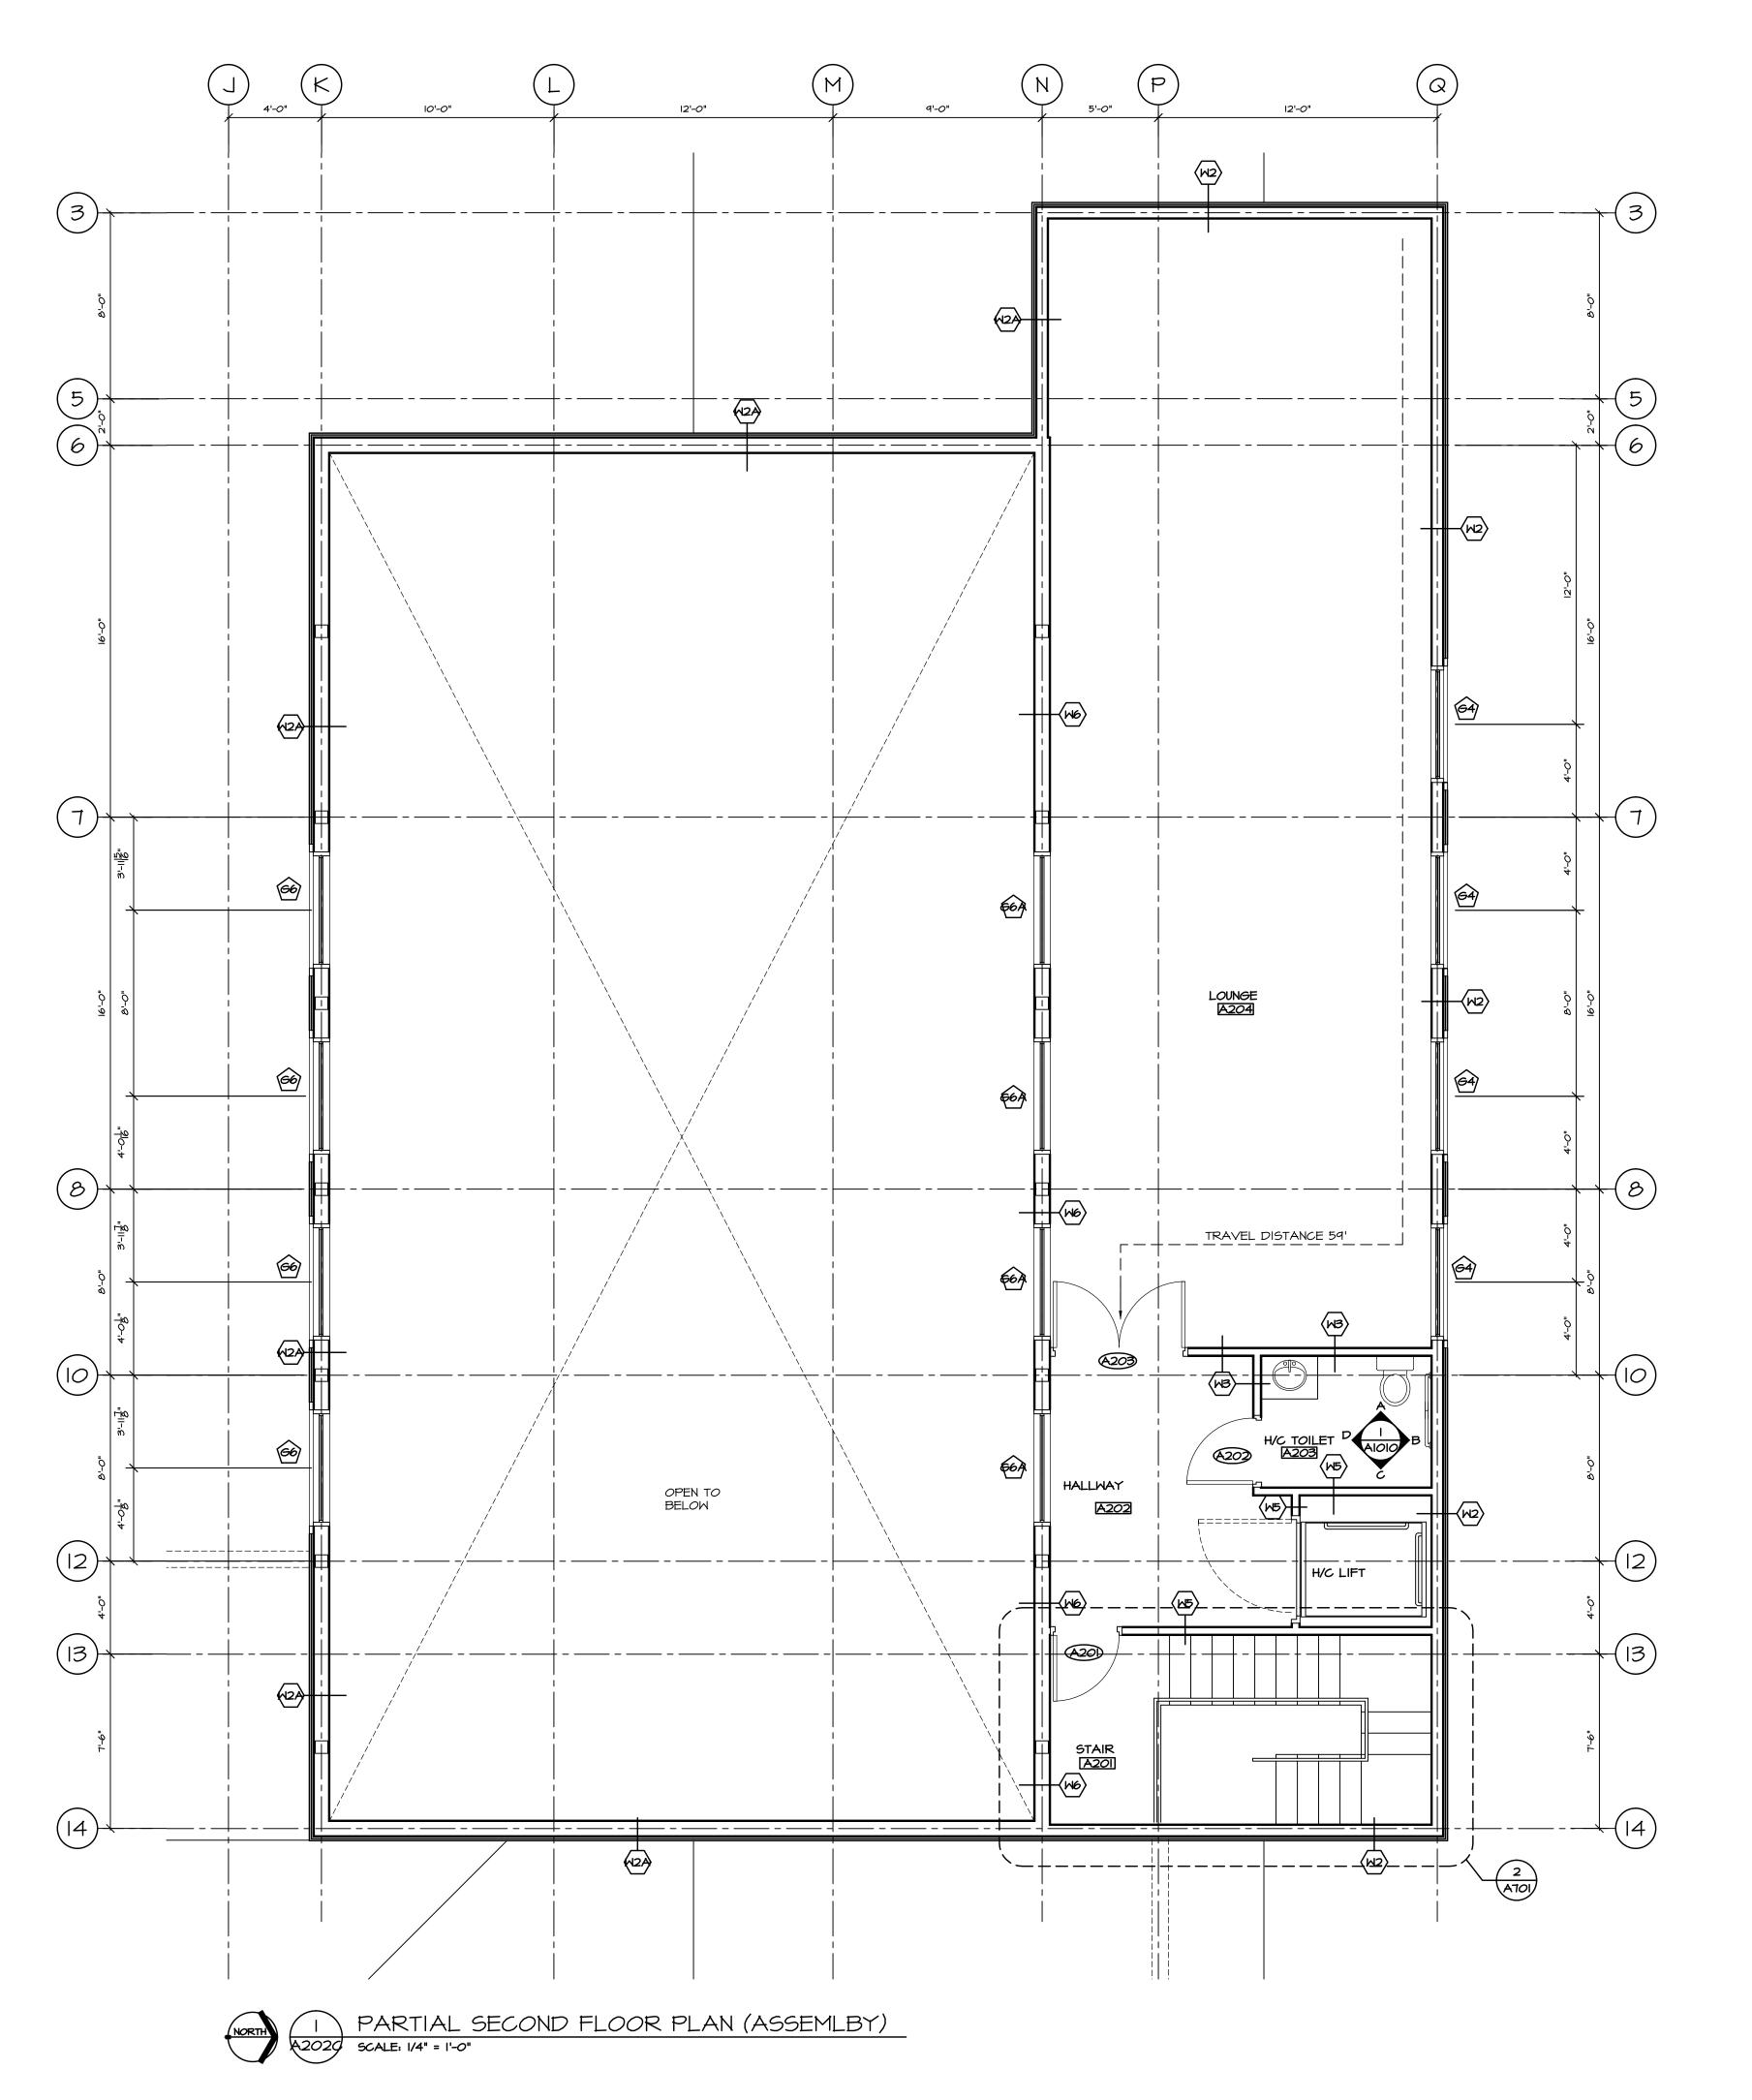

- WALL TYPES TO BE READ IN CONJUNCTION W/WALL NOTATIONS ON THIS SHEET
- DOOR TYPE SEE DOOR SCHEDULE
- GLAZING TYPE SEE WINDOW SCHEDULE
- IOI ROOM NUMBER SEE ROOM FINISH SCHEDULE
- FLOOR TYPE SEE FLOOR TYPES

### **WALL TYPES:**

- FOUNDATION WALL ASSEMBLY:
   I" R5 RIGID INSULATION - DAMPPROOFING - 8" CONCRETE WALL
- FOUNDATION WALL ASSEMBLY:
   8" CONCRETE WALL
- TYP. EXTERIOR WALL ASSEMBLY:
   BOARD AND BATTEN SIDING
  - I/2" P.T. STRAPPING - I" R5 RIGID INSULATION - MOISTURE BARRIER - 1/2" PLYWOOD SHEATHING
  - 2X6 WOOD STUDS @ 16" O.C. - R22 BATT INSULATION - 6 MIL V.B. - 1/2" GYPSUM BOARD (5/8" FOR ALL
- COURT EXTERIOR WALL ASSEMBLY:
   BOARD AND BATTEN SIDING - I/2" P.T. STRAPPING

LOADBEARING WALLS)

- I" R5 RIGID INSULATION - MOISTURE BARRIER - 1/2" PLYWOOD SHEATHING - 2X8 WOOD STUDS @ 16" O.C. - R28 BATT INSULATION

- 6 MIL V.B.

TYP. INTERIOR WALL ASSEMBLY:
- I/2" GYPSUM BOARD (BOTH SIDE - 1/2" GYPSUM BOARD (BOTH SIDES)

- 2X4 WOOD STUDS @ 16" O.C.

- 1/2" GYPSUM BOARD

COURT INTERIOR WALL ASSEMBLY:
- 1/2" GYPSUM BOARD (BOTH SIDES)

- 2X8 WOOD STUDS @ 16" O.C.

- INTERIOR WALL ASSEMBLY:
   I/2" TYPE 'X' GYPSUM BOA - 1/2" TYPE 'X' GYPSUM BOARD (BOTH SIDES) - 2X6 WOOD STUDS @ 16" O.C.
- L HOUR F.R.R. INTERIOR WALL ASSEMBLY ULC #W310: - 5/8" TYPE 'X' GYPSUM BOARD (BOTH SIDES) - 2X4 WOOD STUDS @ 16" O.C.
  - FIRE RETARDANT PLYWOOD AS REQUIRED FOR EQUIPMENT SUPPORT ON WALL
- L HOUR F.R.R. INTERIOR WALL ASSEMBLY ULC #W310: - 5/8" TYPE 'X' GYPSUM BOARD (BOTH SIDES) - 2X8 WOOD STUDS @ 16" O.C. - FIRE RETARDANT PLYWOOD AS REQUIRED FOR EQUIPMENT SUPPORT ON WALL
- ALL LOADBEARING WALLS, POSTS, COLUMNS & SUPPORTS TO HAVE 45 MIN. F.R.R. - USE 5/8" TYPE 'X' GWB IN-LIEU OF 1/2" *G*WB

### **ROOF TYPES:**

- RAFTERS ROOF ASSEMBLY: STANDING SEAM METAL ROOF SYSTEM ROOF MEMBRANE
  - R20 RIGID INSULATION (EFFECTIVE R20) - VAPOUR RETARDER - PLYWOOD SHEATHING PER STRUCT. ENG. - 2X6 ROOF DECKING (T&G) - ROOF RAFTERS
- <u>GYM ROOF ASSEMBLY:</u> STANDING SEAM METAL ROOF SYSTEM

TO BE PAINTED)

- R20 RIGID INSULATION (EFFECTIVE R20) - VAPOUR RETARDER
- ROOF MEMBRANE - PLYWOOD SHEATHING PER STRUCT. ENG. - 2X6 ROOF DECKING (T&G) - ROOF TRUSSES SYSTEM (EXPOSED STEEL
- RAFTERS SOFFIT ASSEMBLY:
   STANDING SEAM METAL ROOF SYSTEM ROOF MEMBRANE - R20 RIGID INSULATION (EFFECTIVE R20) - VAPOUR RETARDER - PLYWOOD SHEATHING PER STRUCT. ENG. - 2X6 WOOD DECKING - ROOF RAFTERS

### **FLOOR TYPES:**

- FI SLAB-ON-GRAD FLOOR ASSEMBLY:
   FLOOR FINISH - SLAB-ON-GRADE PER STRUCT. - 6 MIL POLY V.B. - RIO RIGID INSULATION - COMPACTED SOIL
- F2 FLOOR ASSEMBLY (TYP.):
   FLOOR FINISH
   3/4" PLYWOOD SHEATHIN - 3/4" PLYWOOD SHEATHING - FLOOR JOIST PER STRUCT. ENG. - 5/8" TYPE 'X' GYPSUM BOARD 45 MIN. FIRE SEPARATION (BCBC ACCUMULATIVE METHOD)

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All work shall conform to the current local Building Code,

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DEC 15/17	ISSUED FOR INAC		
NOY 22/17	ISSUED FOR REVIEW	<u>_</u>	
ATE	REMARKS	NO.	
RAWING REVISIONS / ISSUES			

Scott M. Kemp Architect

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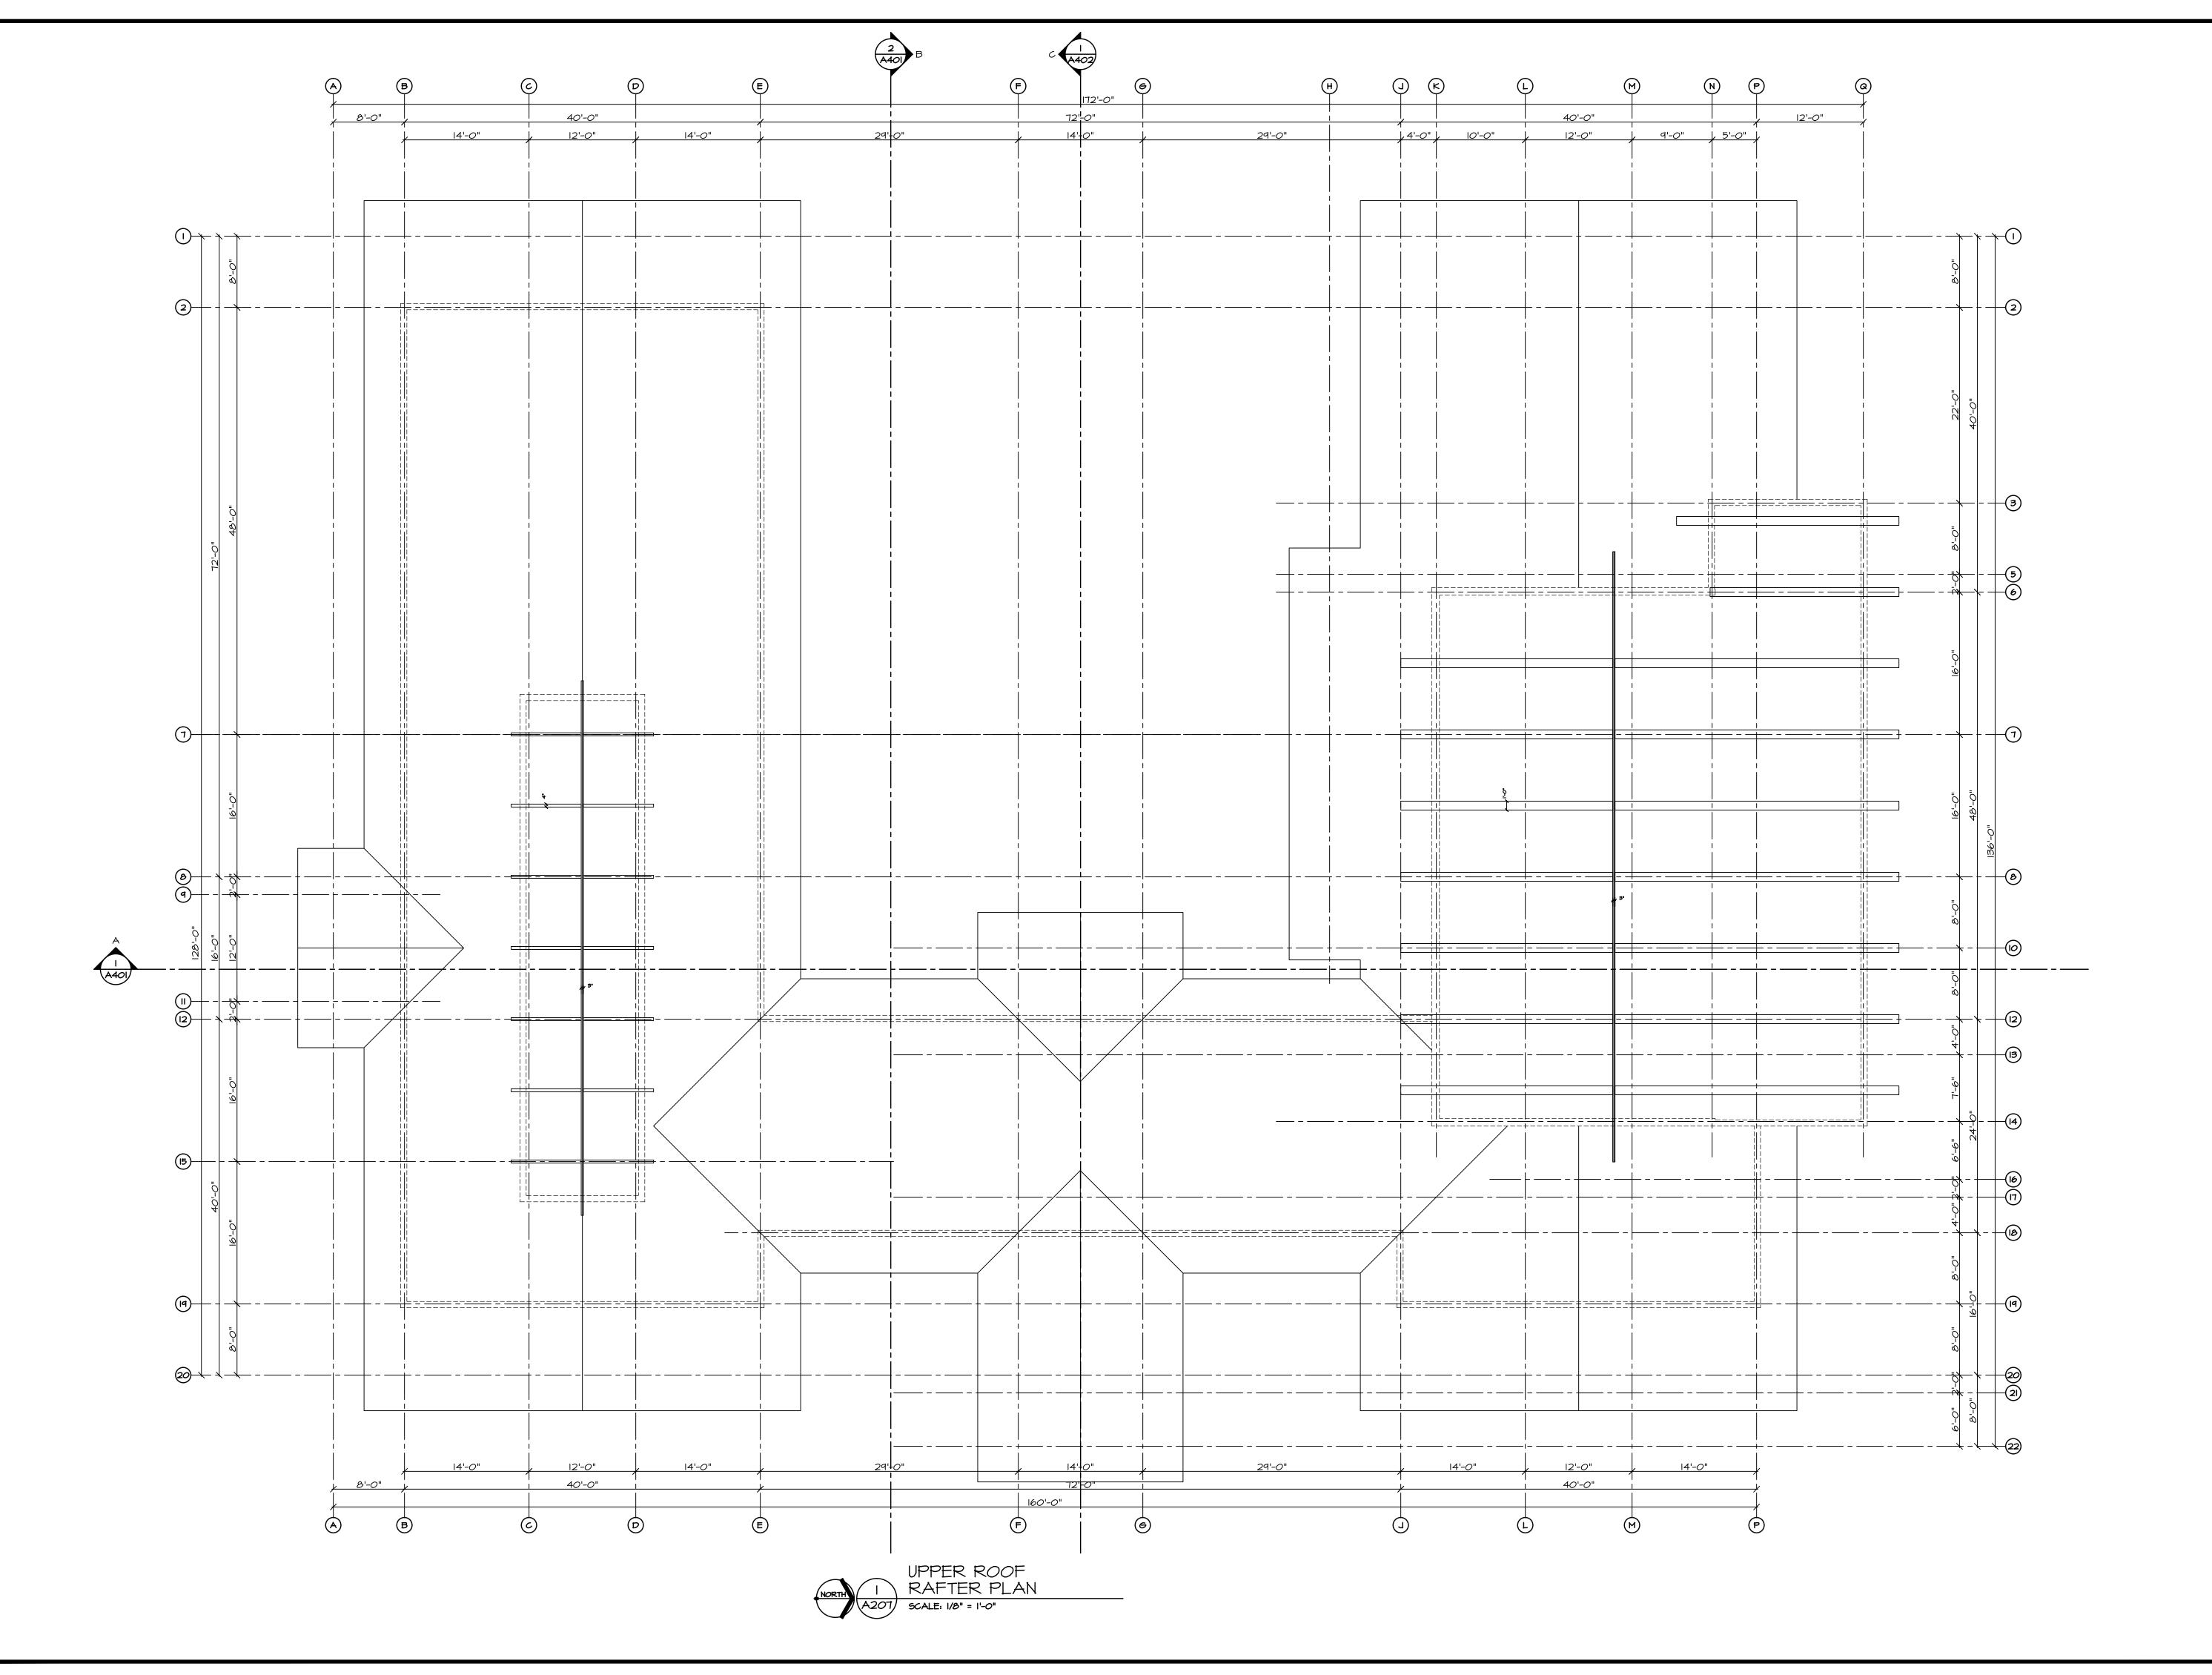
PROJECT

MALAHAT MULTIPURPOSE CULTURAL CENTRE

Malahat, BC

DRAWING TITLE PARTIAL SECOND FLOOR PLAN (ASSEMBLY)

	DRAWN ML	DATE MAR./IT
	CHK'D SK	JOB No.
	DESIGN	DRAWING No.
	CHK'D _	A206A
•	SCALE AS SHOWN	



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SEP. 17/17	ISSUED FOR REVIEW	<u>_</u>		
AUG. OI/IT	ISSUED FOR REVIEW	<u>_</u>		
DATE	REMARKS	NO.		
DRAWING REVISIONS / ISSUES				

Scott M. Kemp Architect

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PROJECT

MALAHAT MULTIPURPOSE CULTURAL CENTRE


Malahat, BC

DRAWING TITLE

UPPER ROOF

RAFTER PLAN

DRAWN	ML	DATE	AUG/IT
CHK'D	5K	JOB No.	-
DESIGN		DRAWING	No.
CHK'D	-	A	207
SCALE	AS SHOWN		

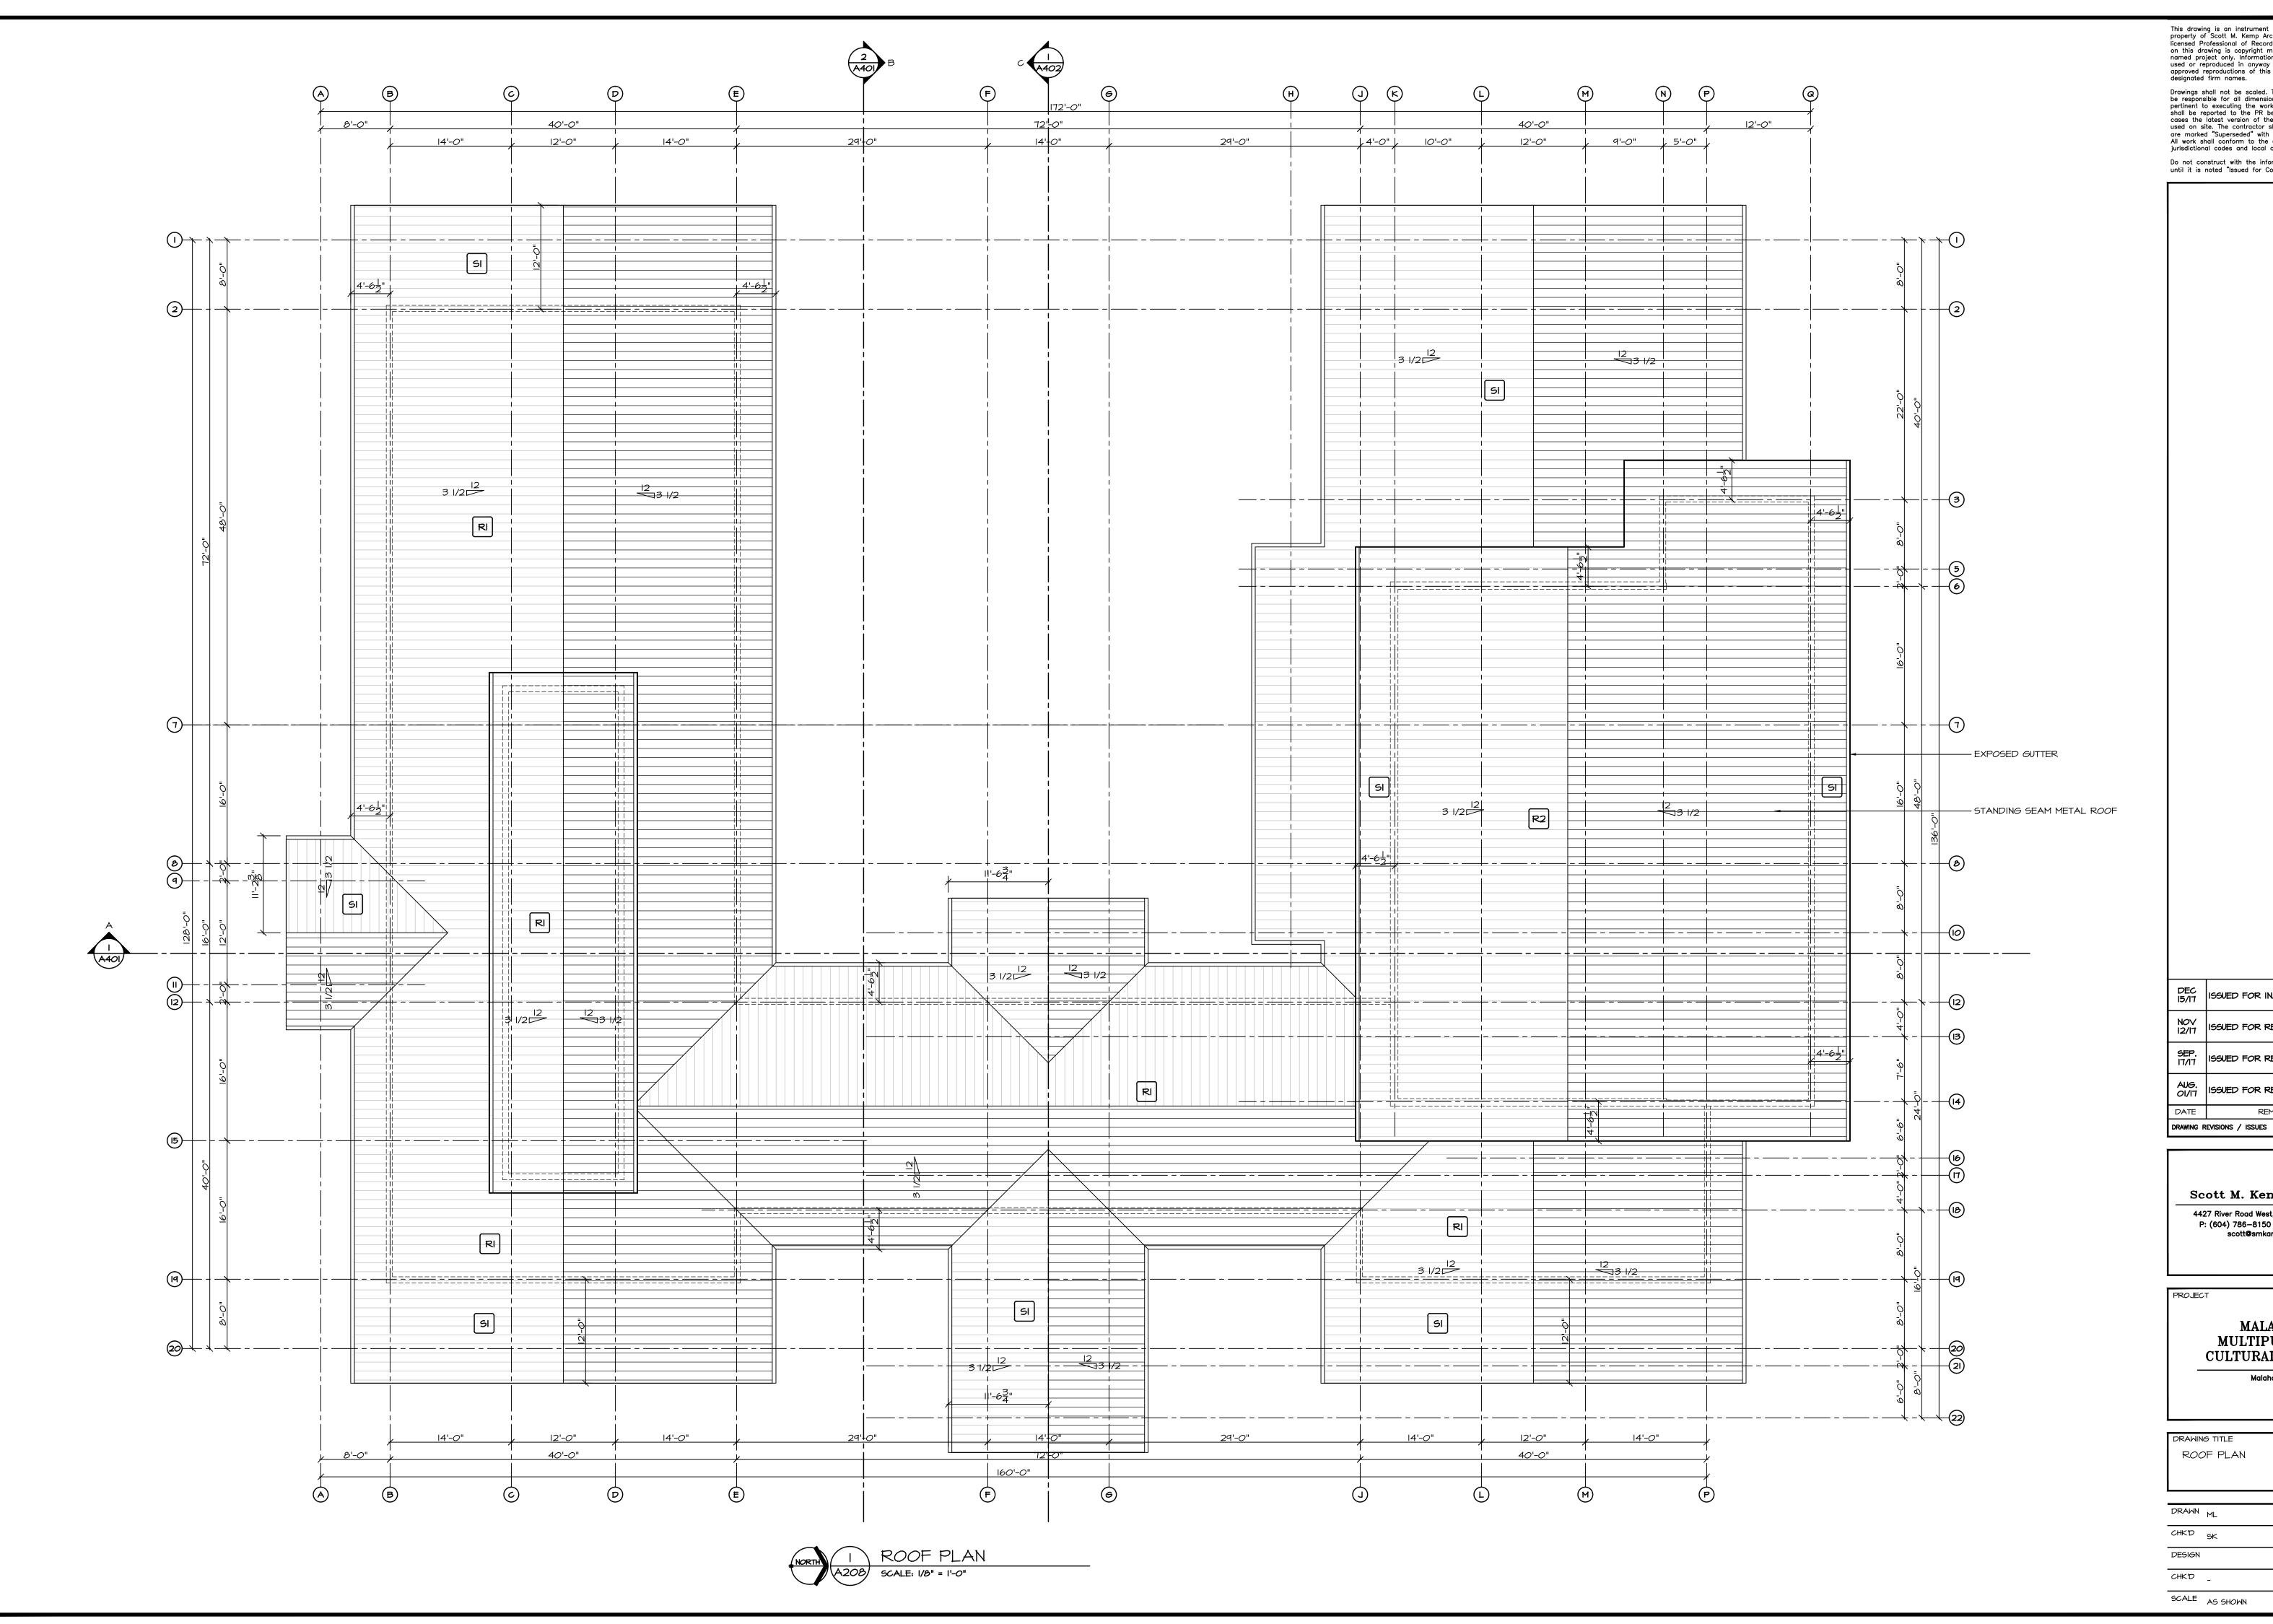

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SEP. 17/17	ISSUED FOR REVIEW	<u>_</u>
AUG. OI/I7	ISSUED FOR REVIEW	<u>_</u>
DATE	REMARKS	NO.
DRAWING R	EVISIONS / ISSUES	


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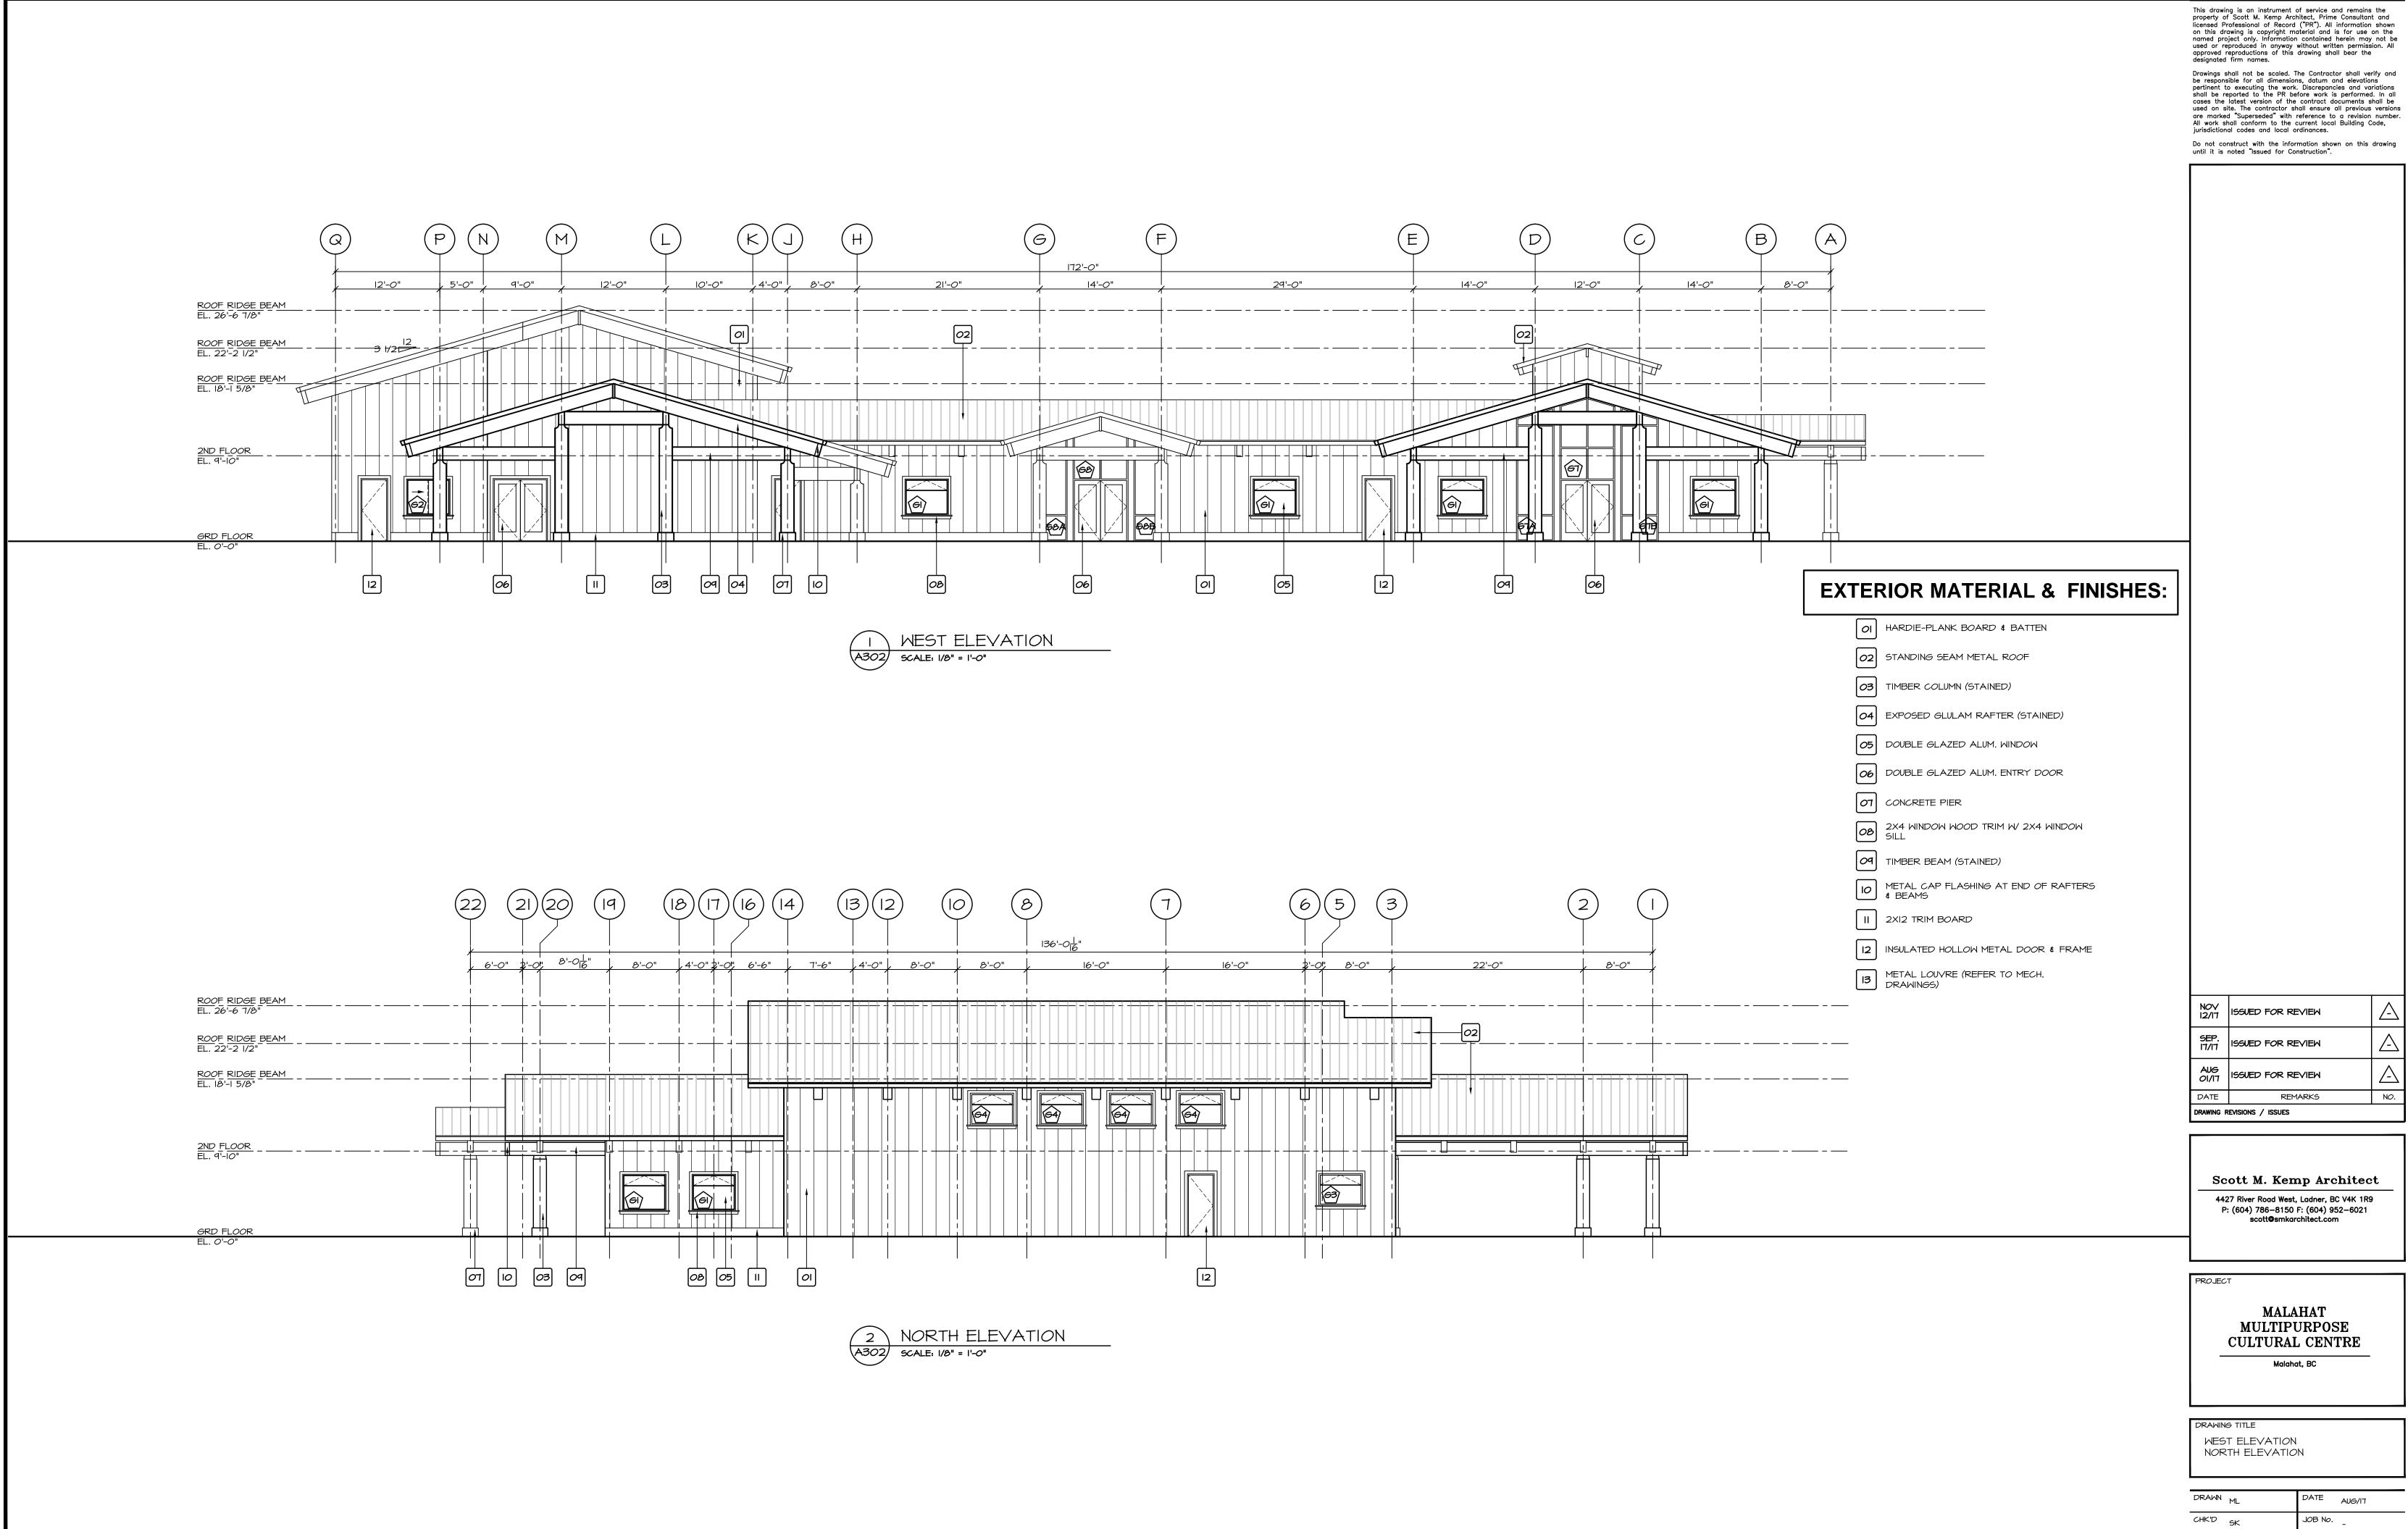
MALAHAT MULTIPURPOSE CULTURAL CENTRE Malahat, BC

ROOF PLAN

DRAWN	ML	DATE	AUG./IT
CHK'D	SK	JOB No.	-
DESIGN		DRAWING	No.
CHK'D	-	A <sup>2</sup>	208
SCALE	AS SHOWN		



DRAWN	ML	DATE	AUG/IT
CHK'D	5K	JOB No.	-
DESIGN		DRAWING	No.
CHK'D	-	Α	301
SCALE	AS SHOWN	'`	<b>.</b>

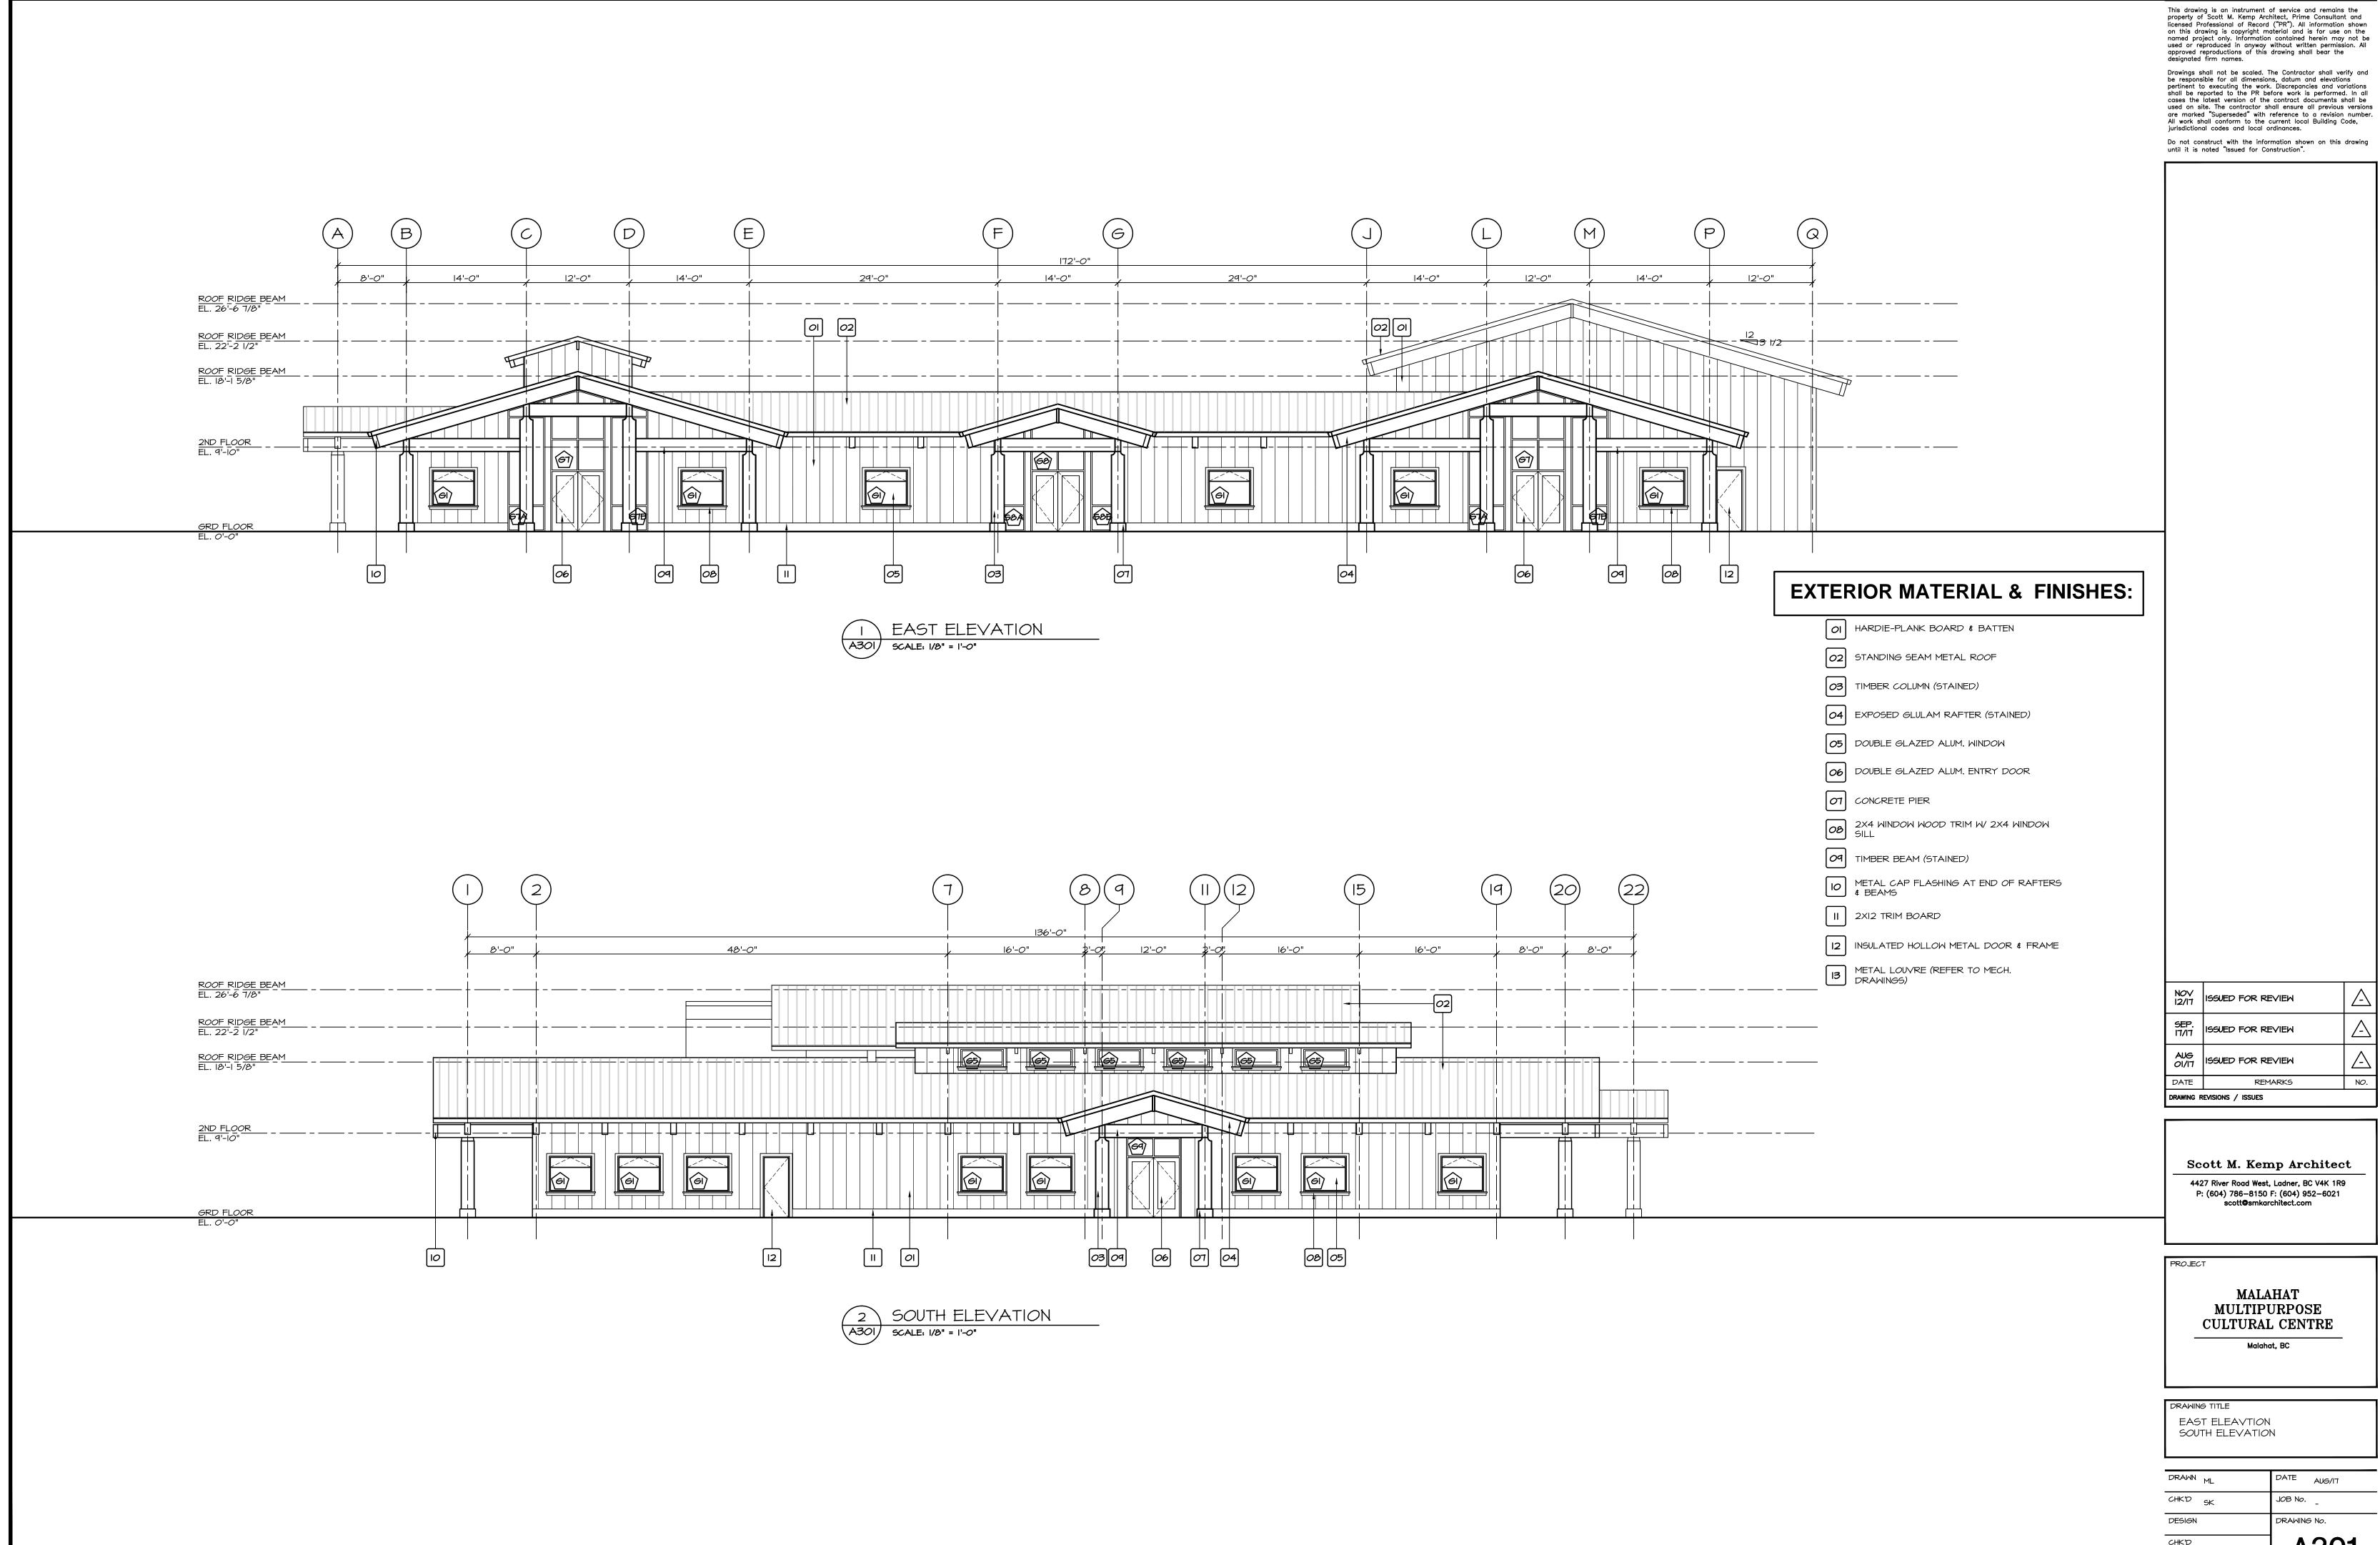

DRAWN ML


CHK'D SK

DESIGN

DRAWING NO.


CHK'D \_

SCALE AS SHOWN

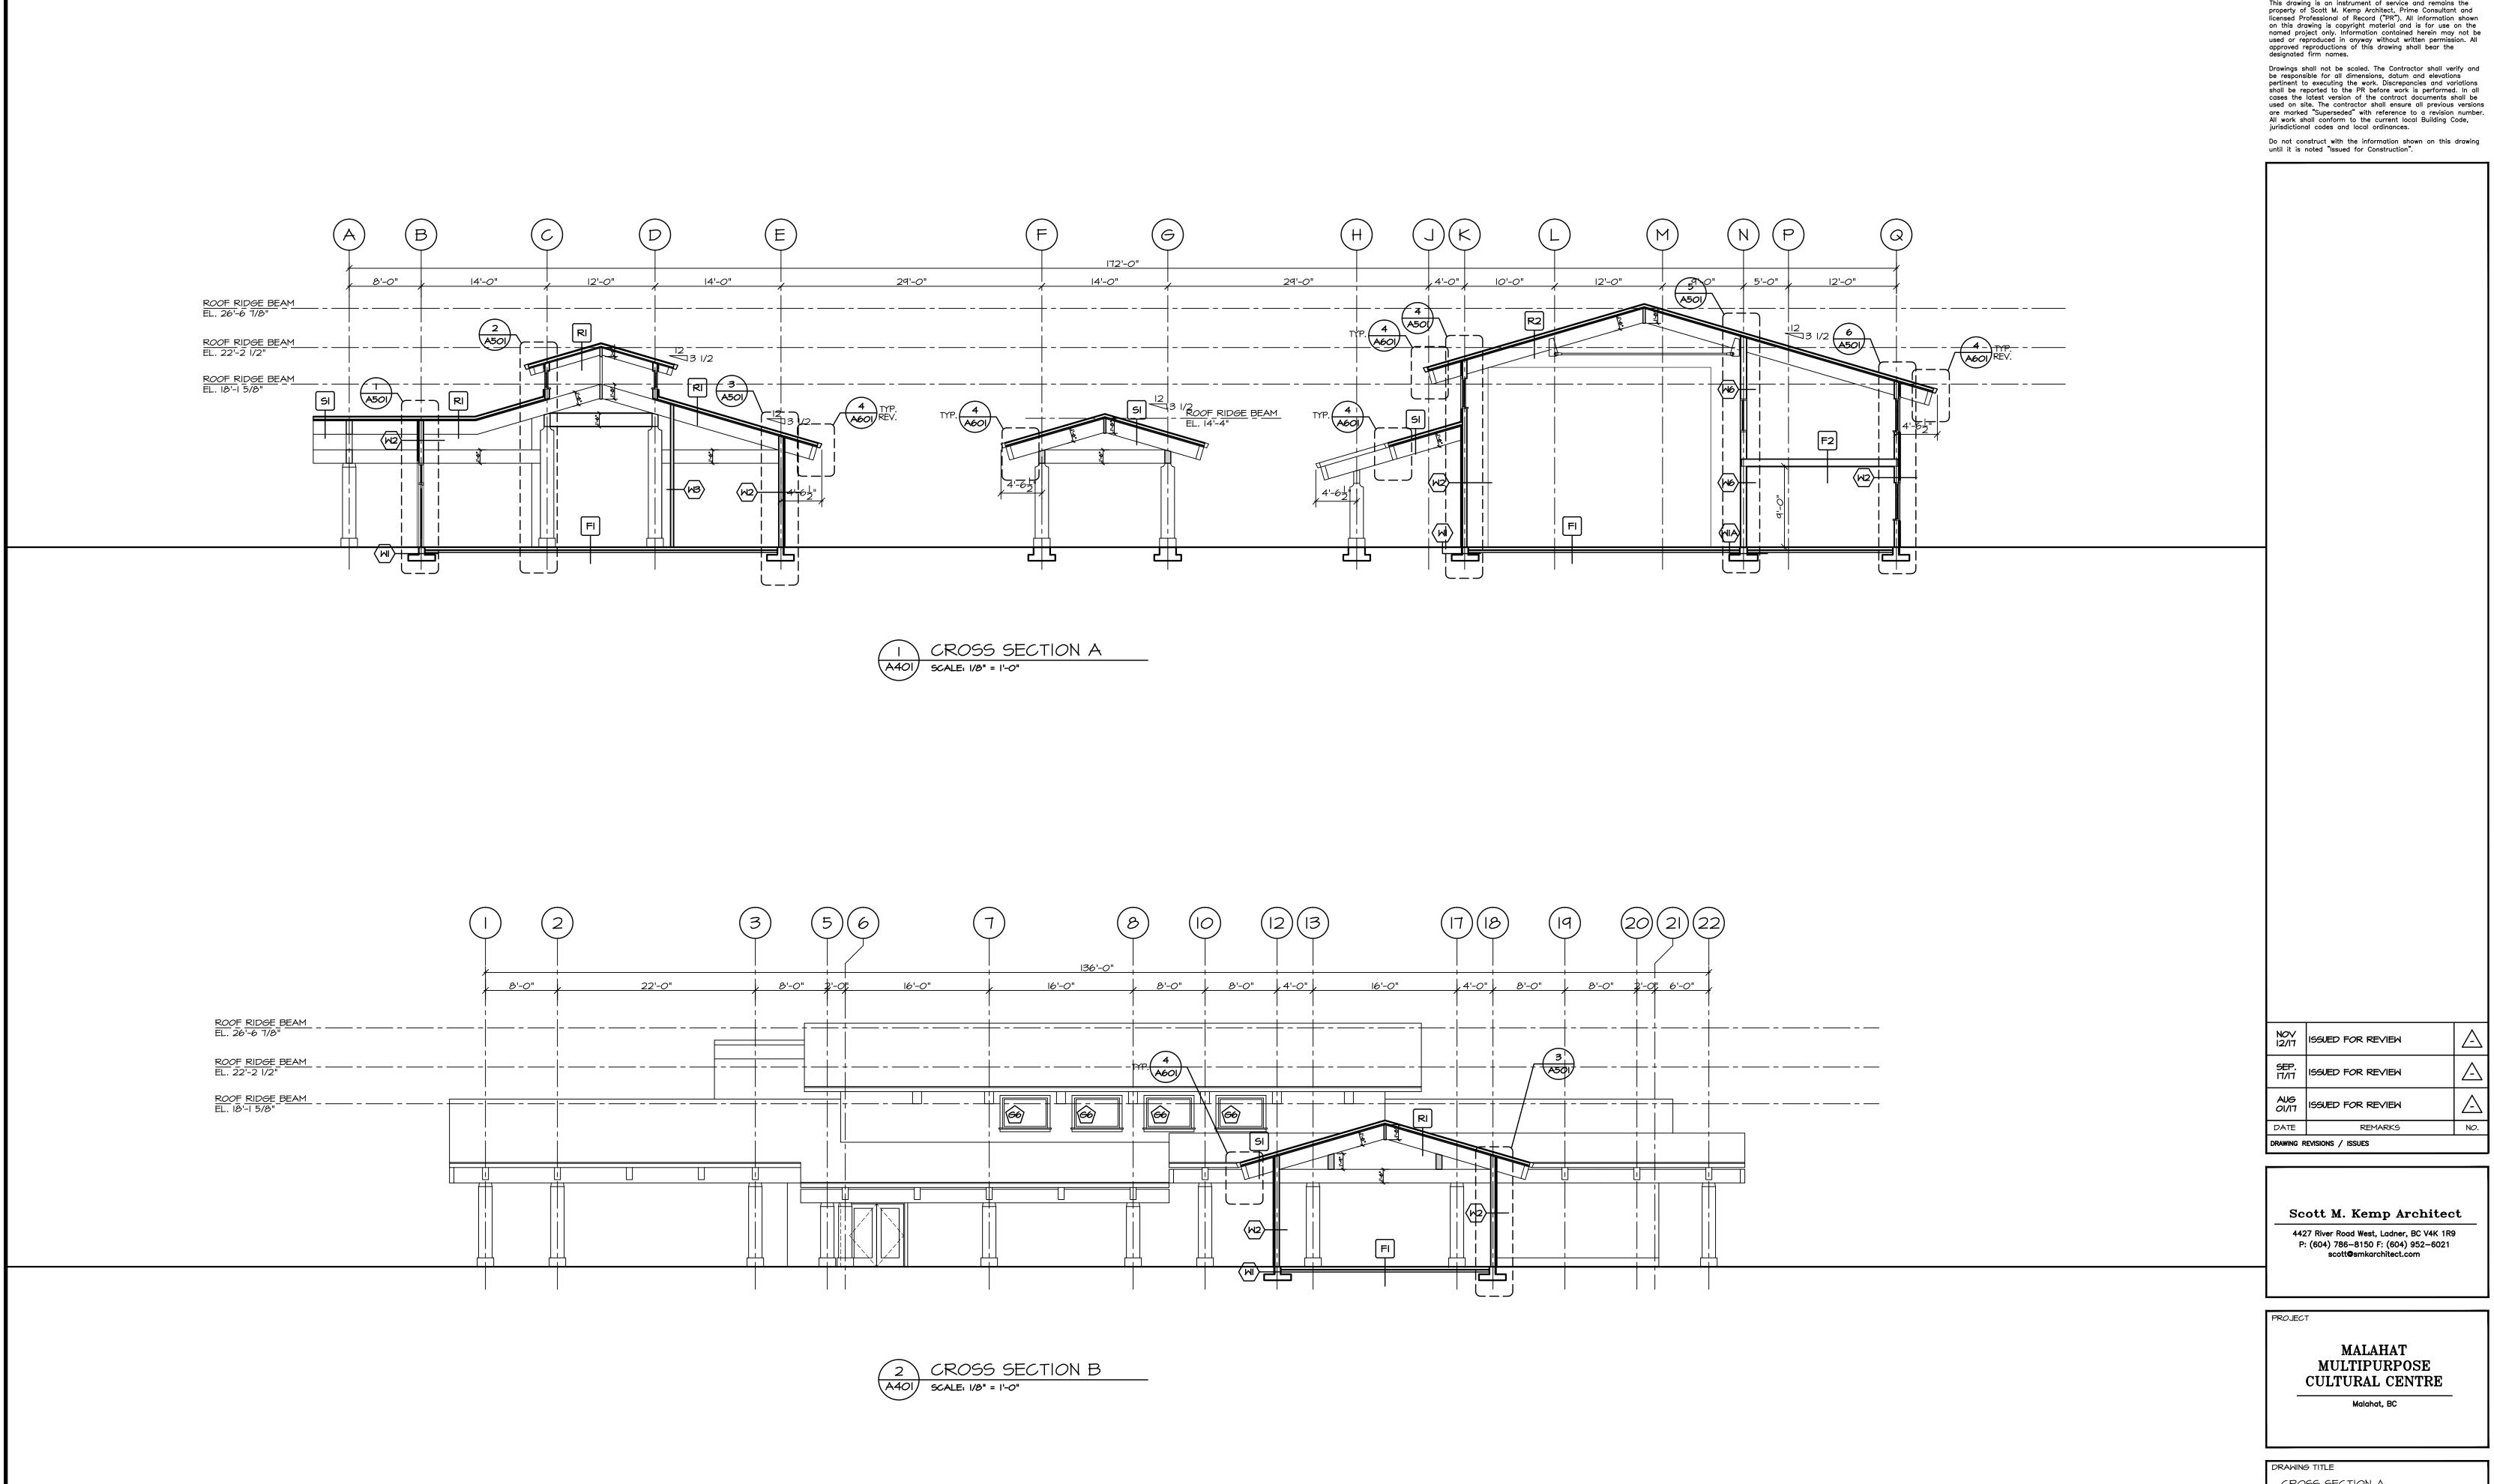

CROSS SECTION A CROSS SECTION B

DRAWN	ML	DATE	AUG/IT
CHK'D	5K	JOB No.	-
DESIGN		DRAWING	No.
CHK'D	-	Α	401
SCALE	AS SHOWN		

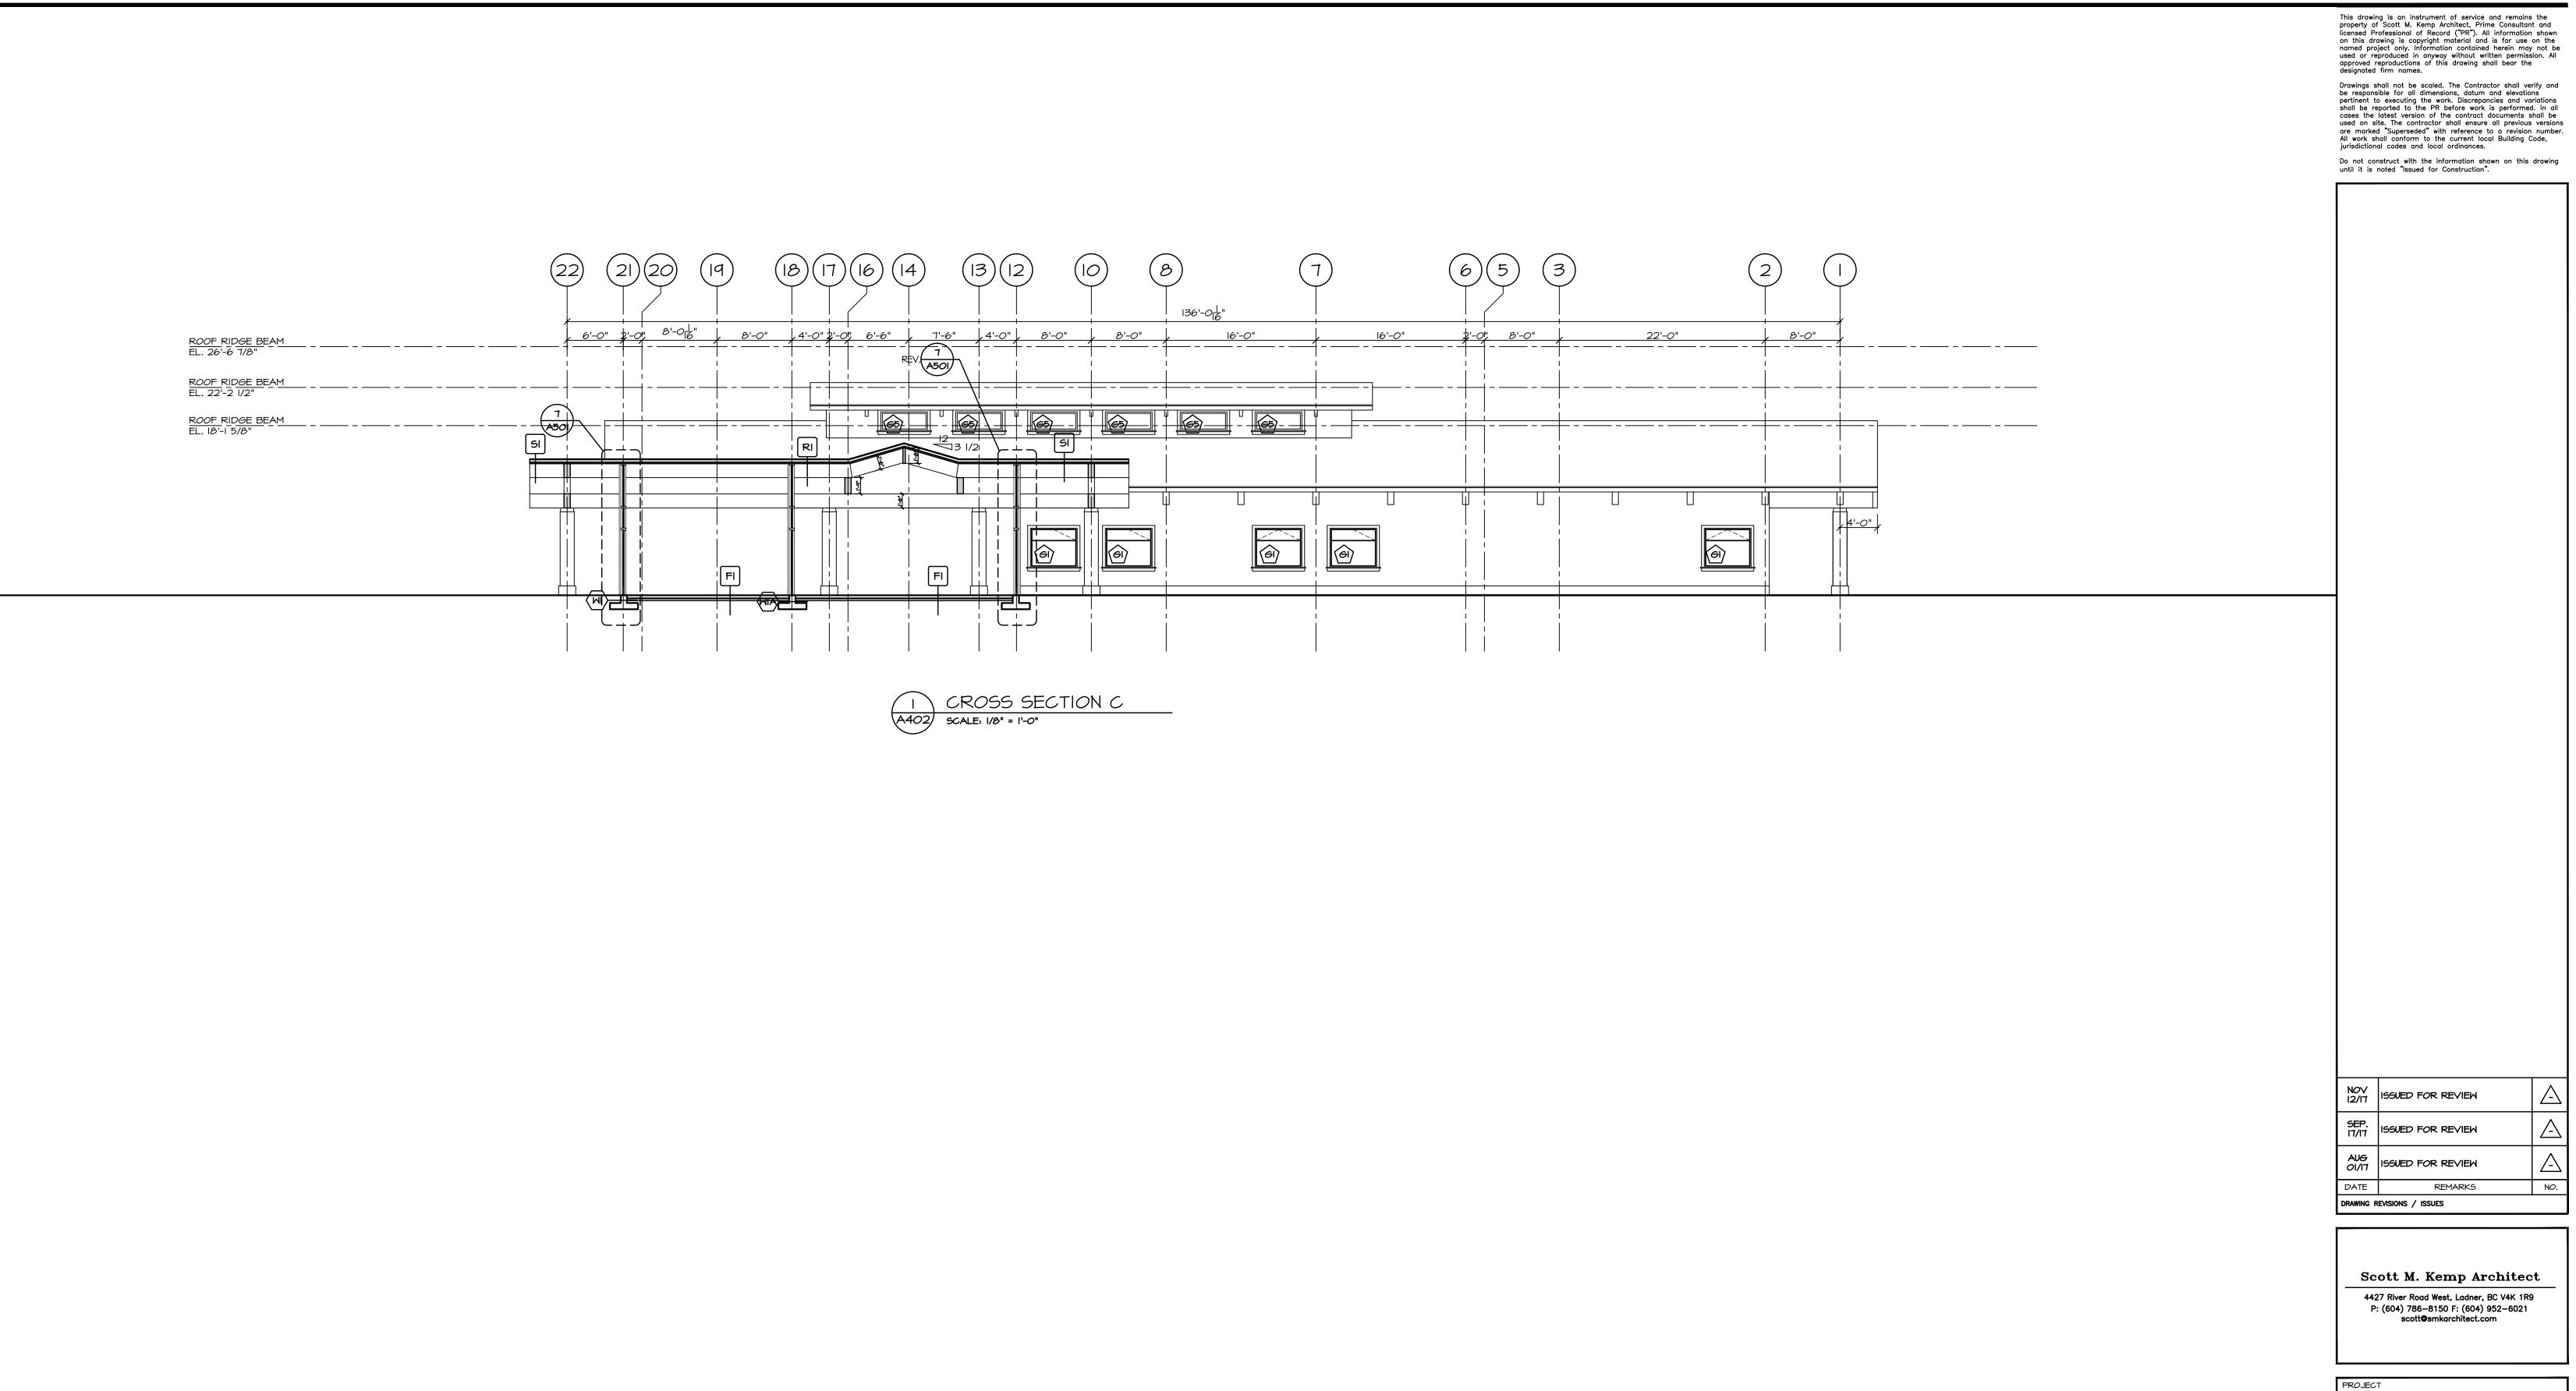

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REMARKS

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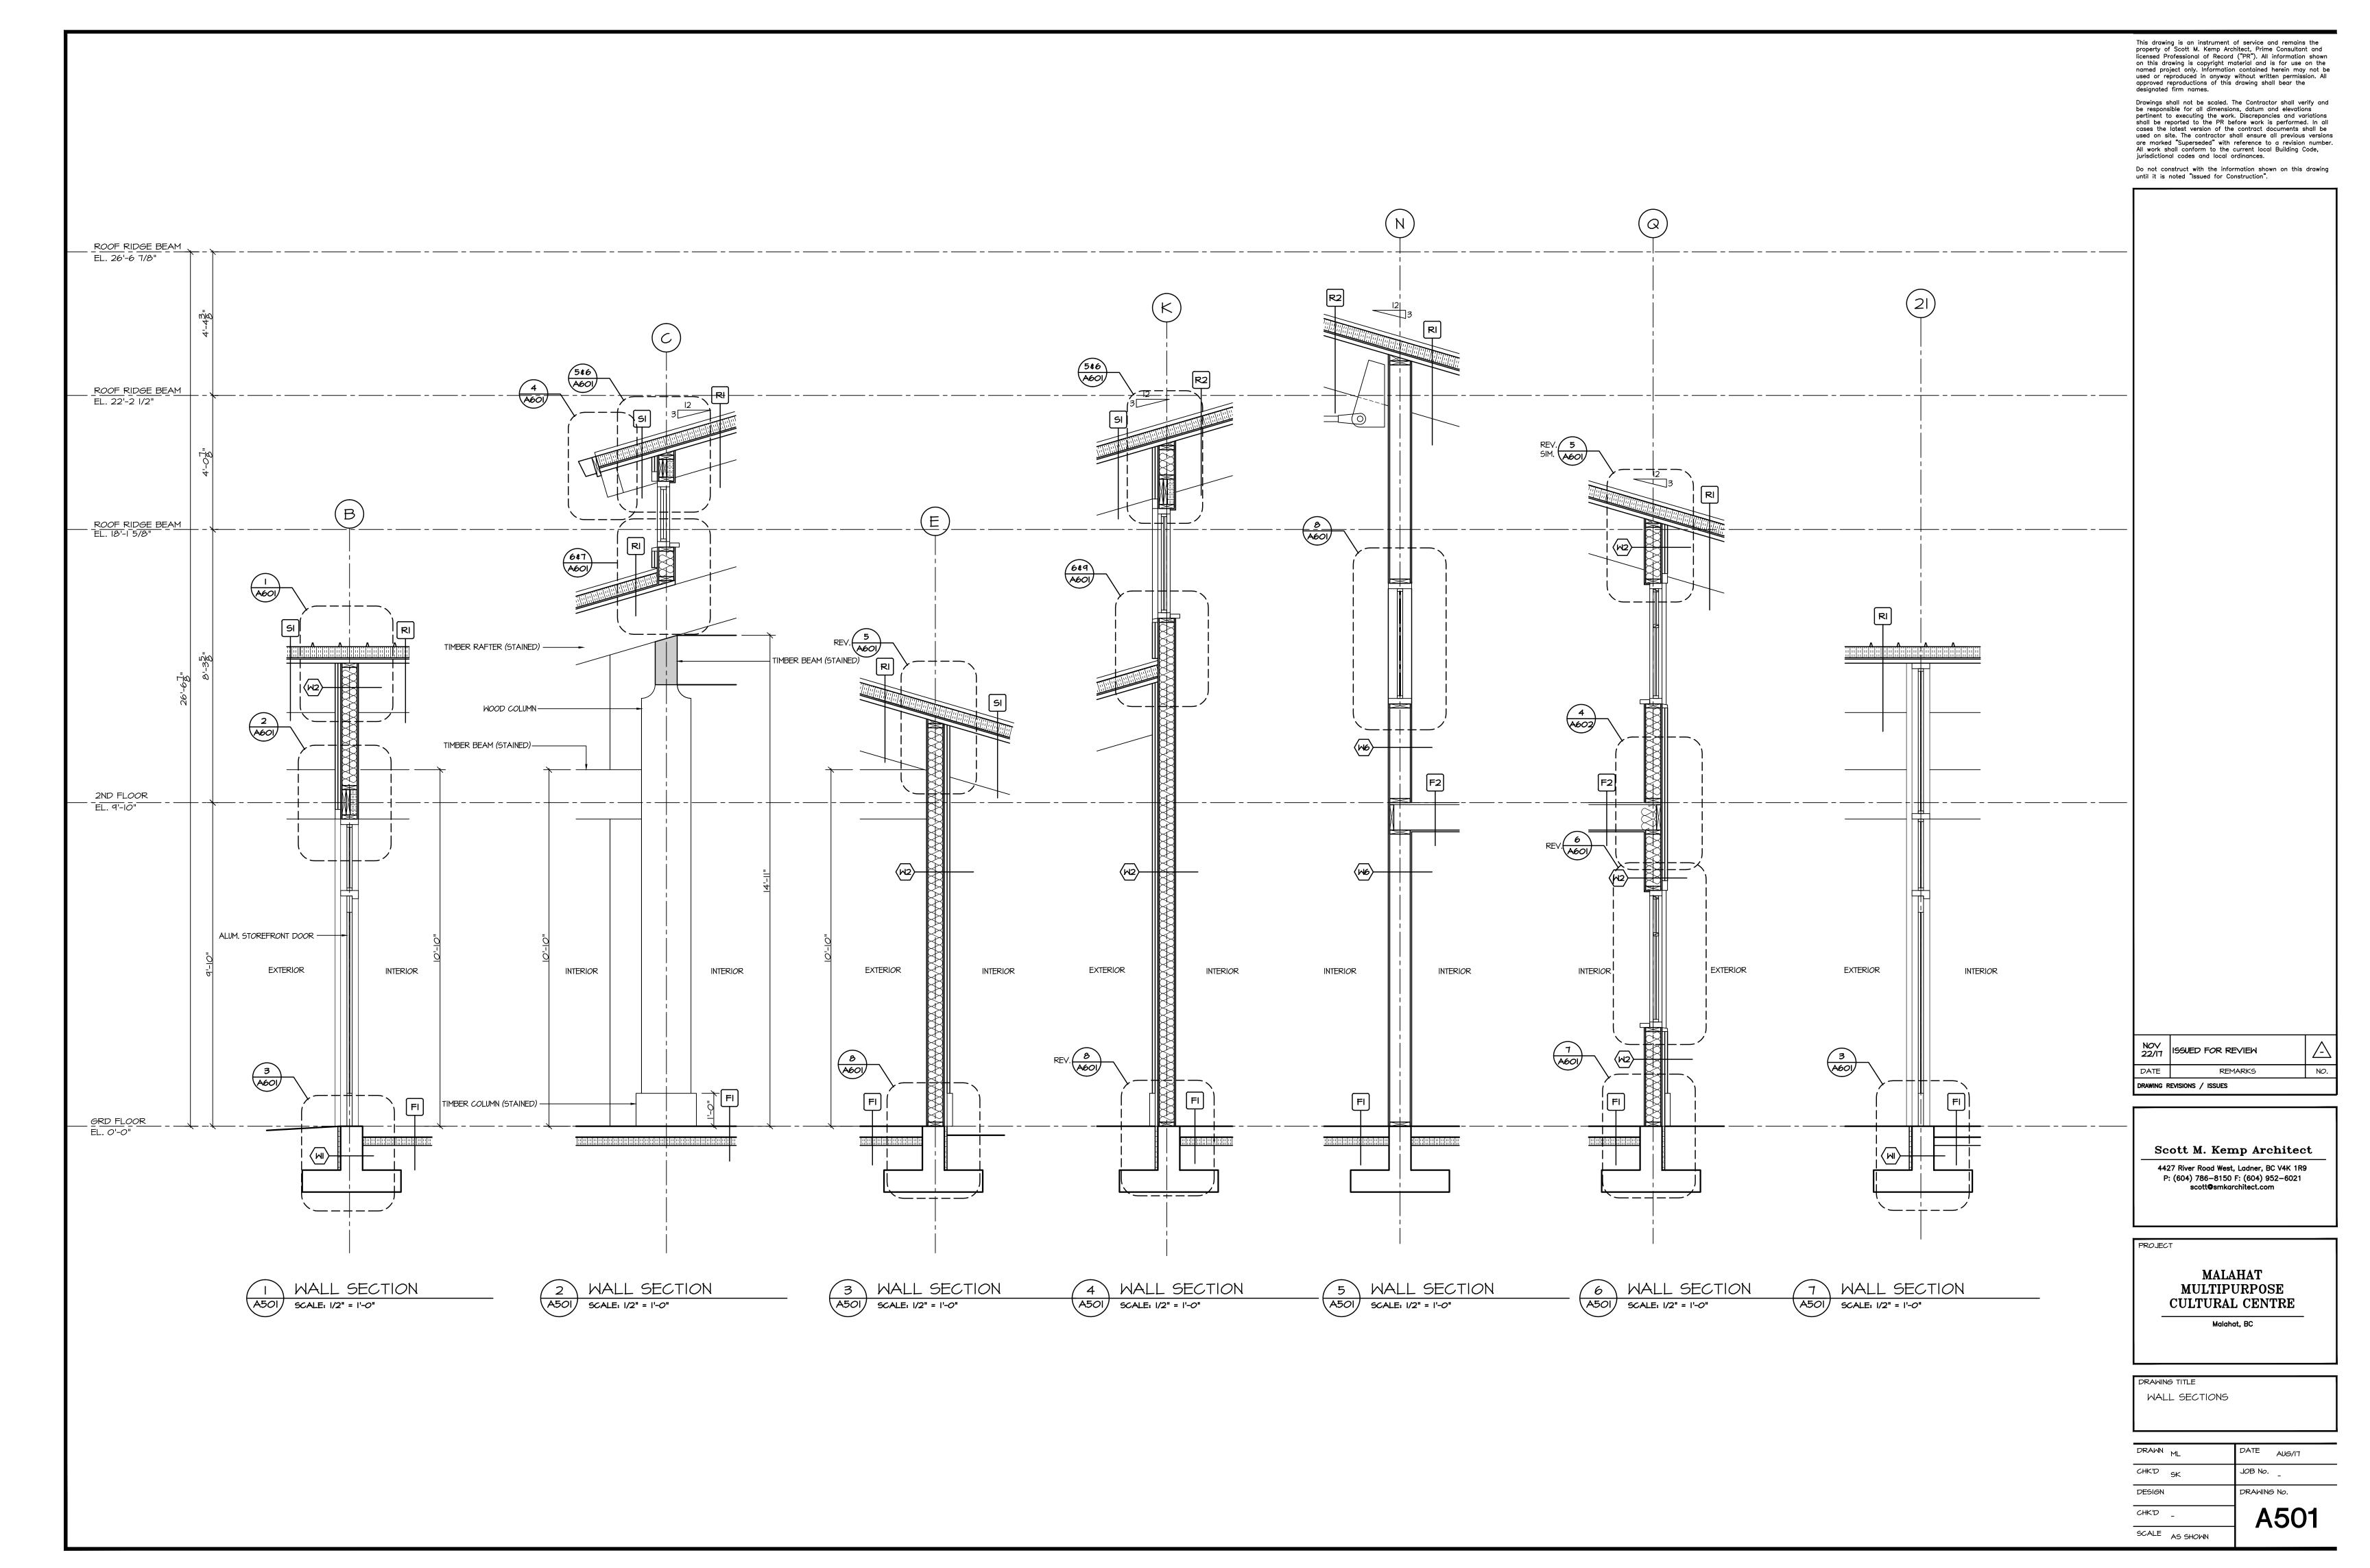
MALAHAT MULTIPURPOSE CULTURAL CENTRE


Malahat, BC

DRAWING TITLE CROSS SECTION C

SCALE AS SHOWN

•	CHK'D _	A402
•	DESIGN	DRAWING No.
·	CHK'D SK	JOB No
	DRAWN ML	DATE AUG/IT



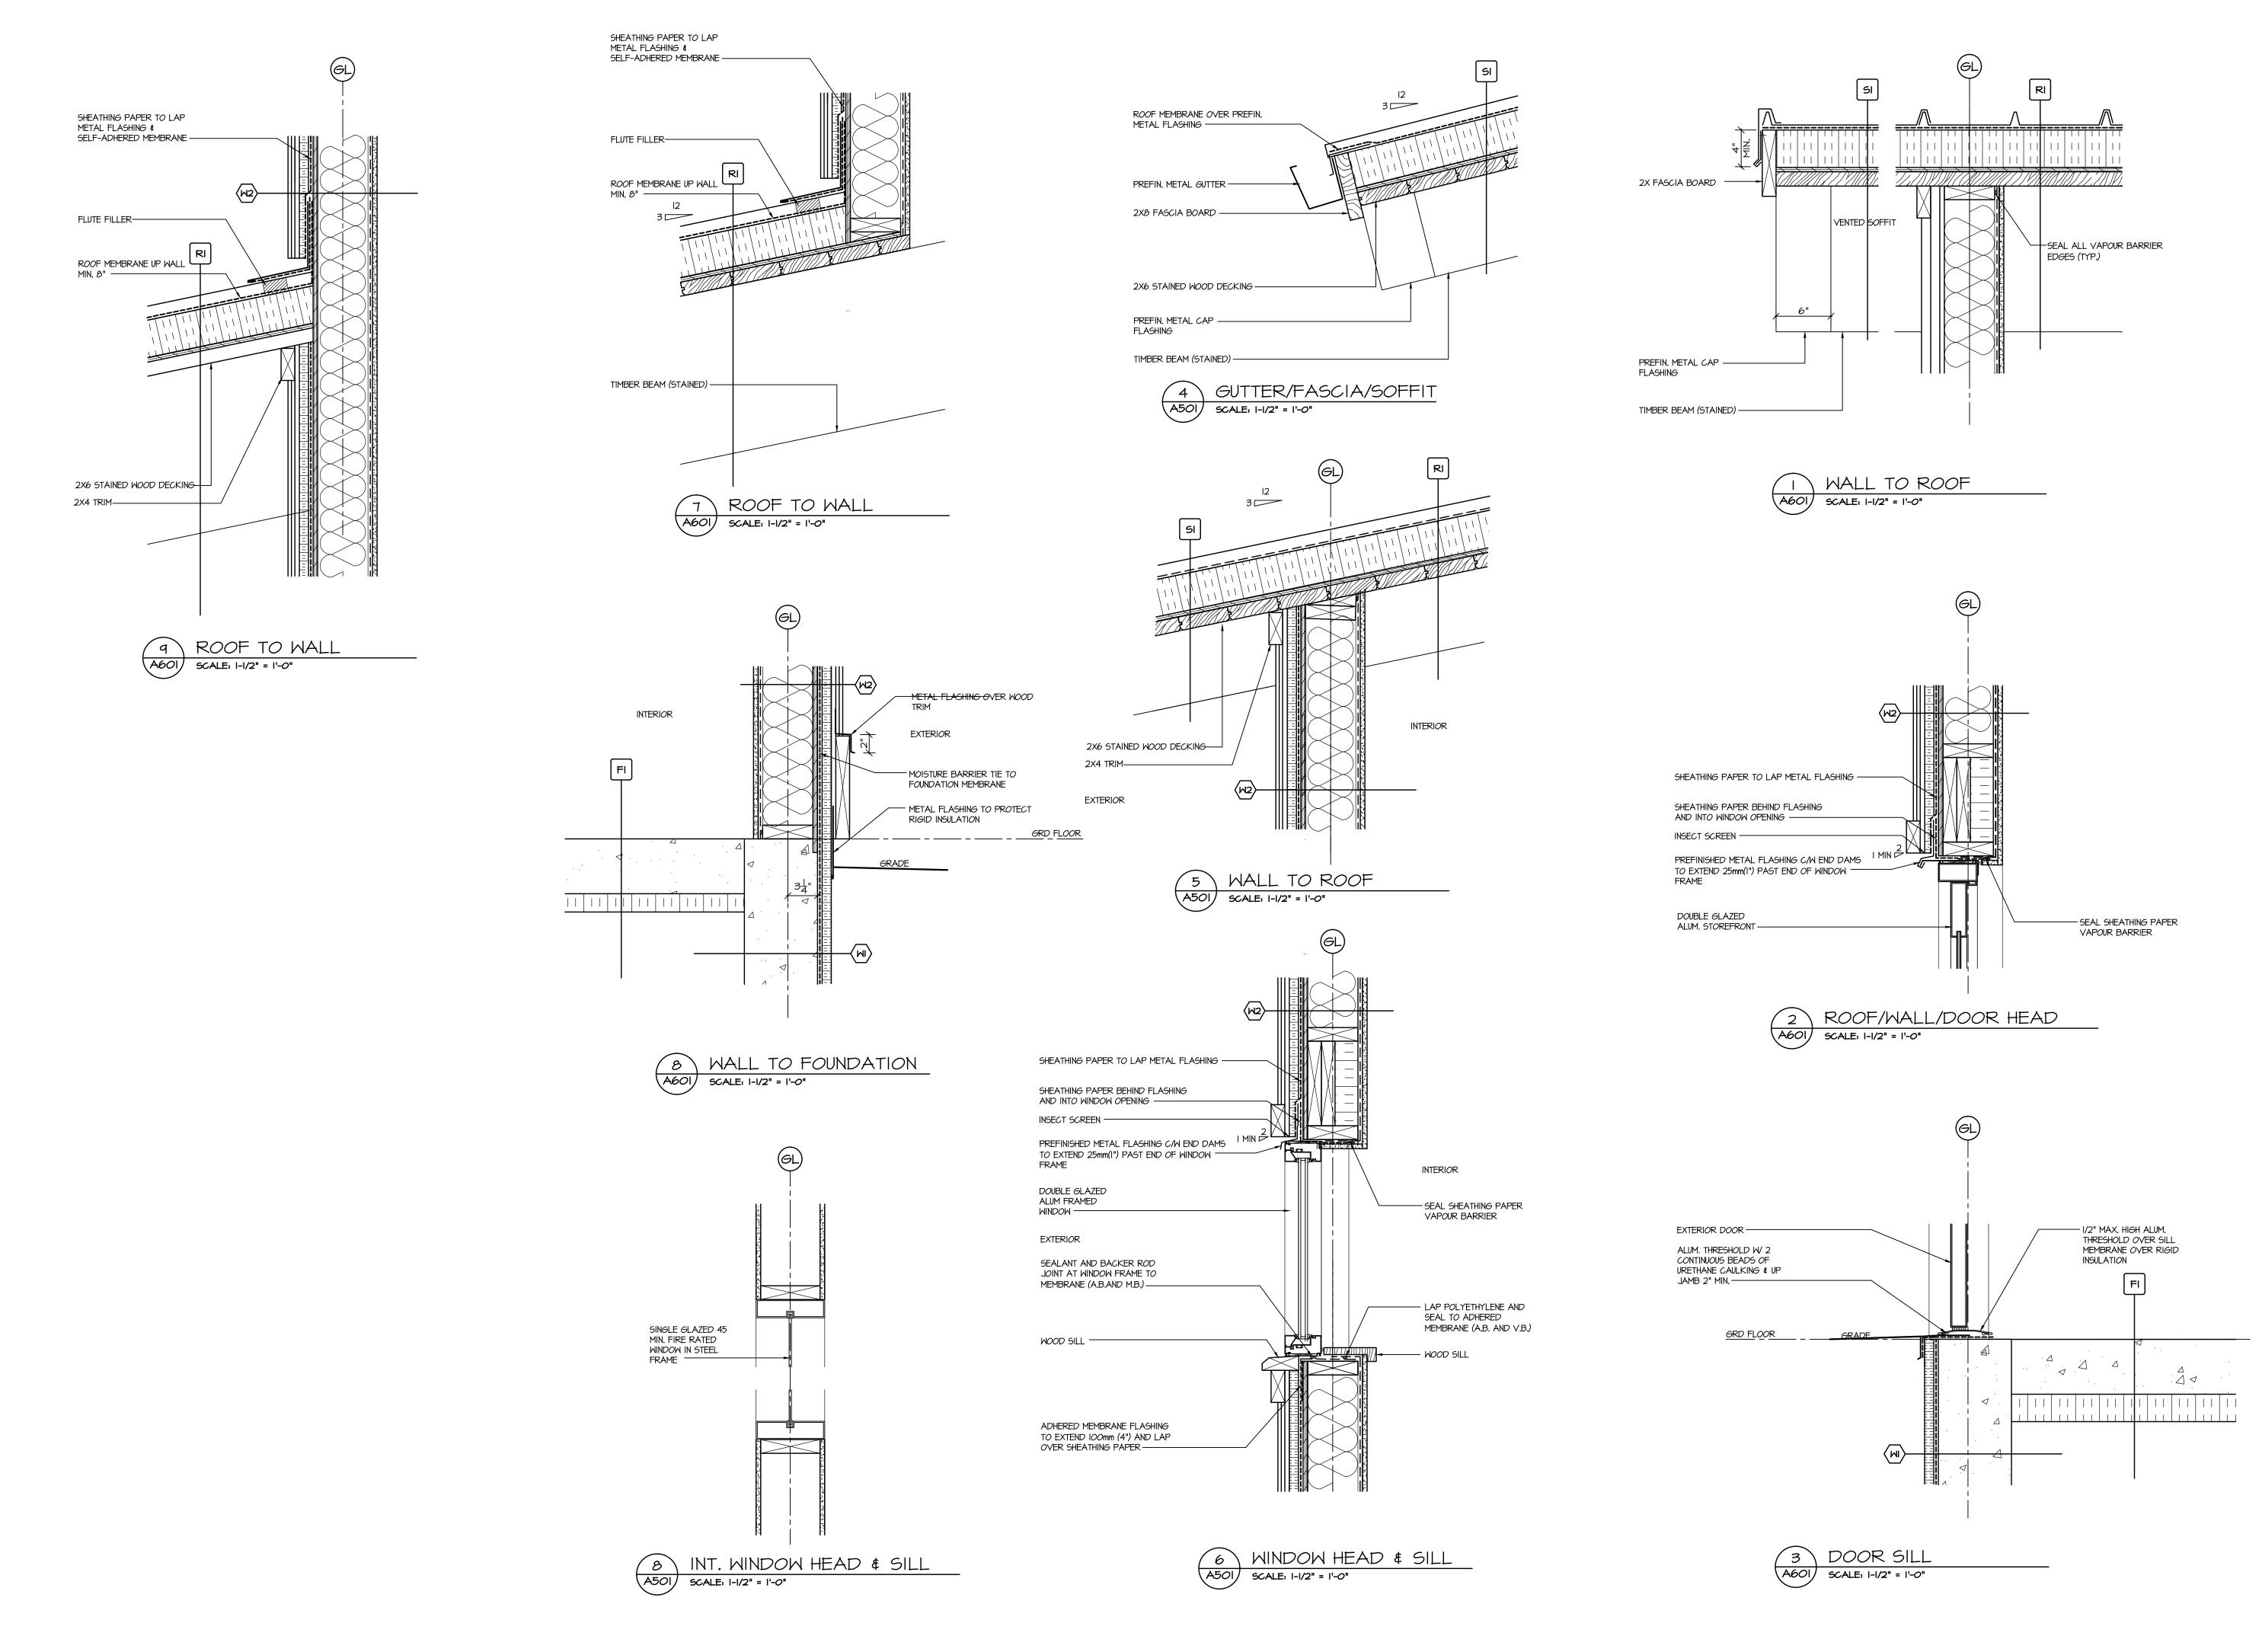

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NOV 22/17 ISSUED FOR REVIEW

DATE REMARKS NO.

DRAWING REVISIONS / ISSUES

Scott M. Kemp Architect

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scott@smkarchitect.com

MALAHAT
MULTIPURPOSE
CULTURAL CENTRE

Malahat, BC

DETAILS


DRAWN ML DATE AUG/IT


CHK'D SK JOB No. \_

DESIGN DRAWING No.

CHK'D \_

SCALE AS SHOWN

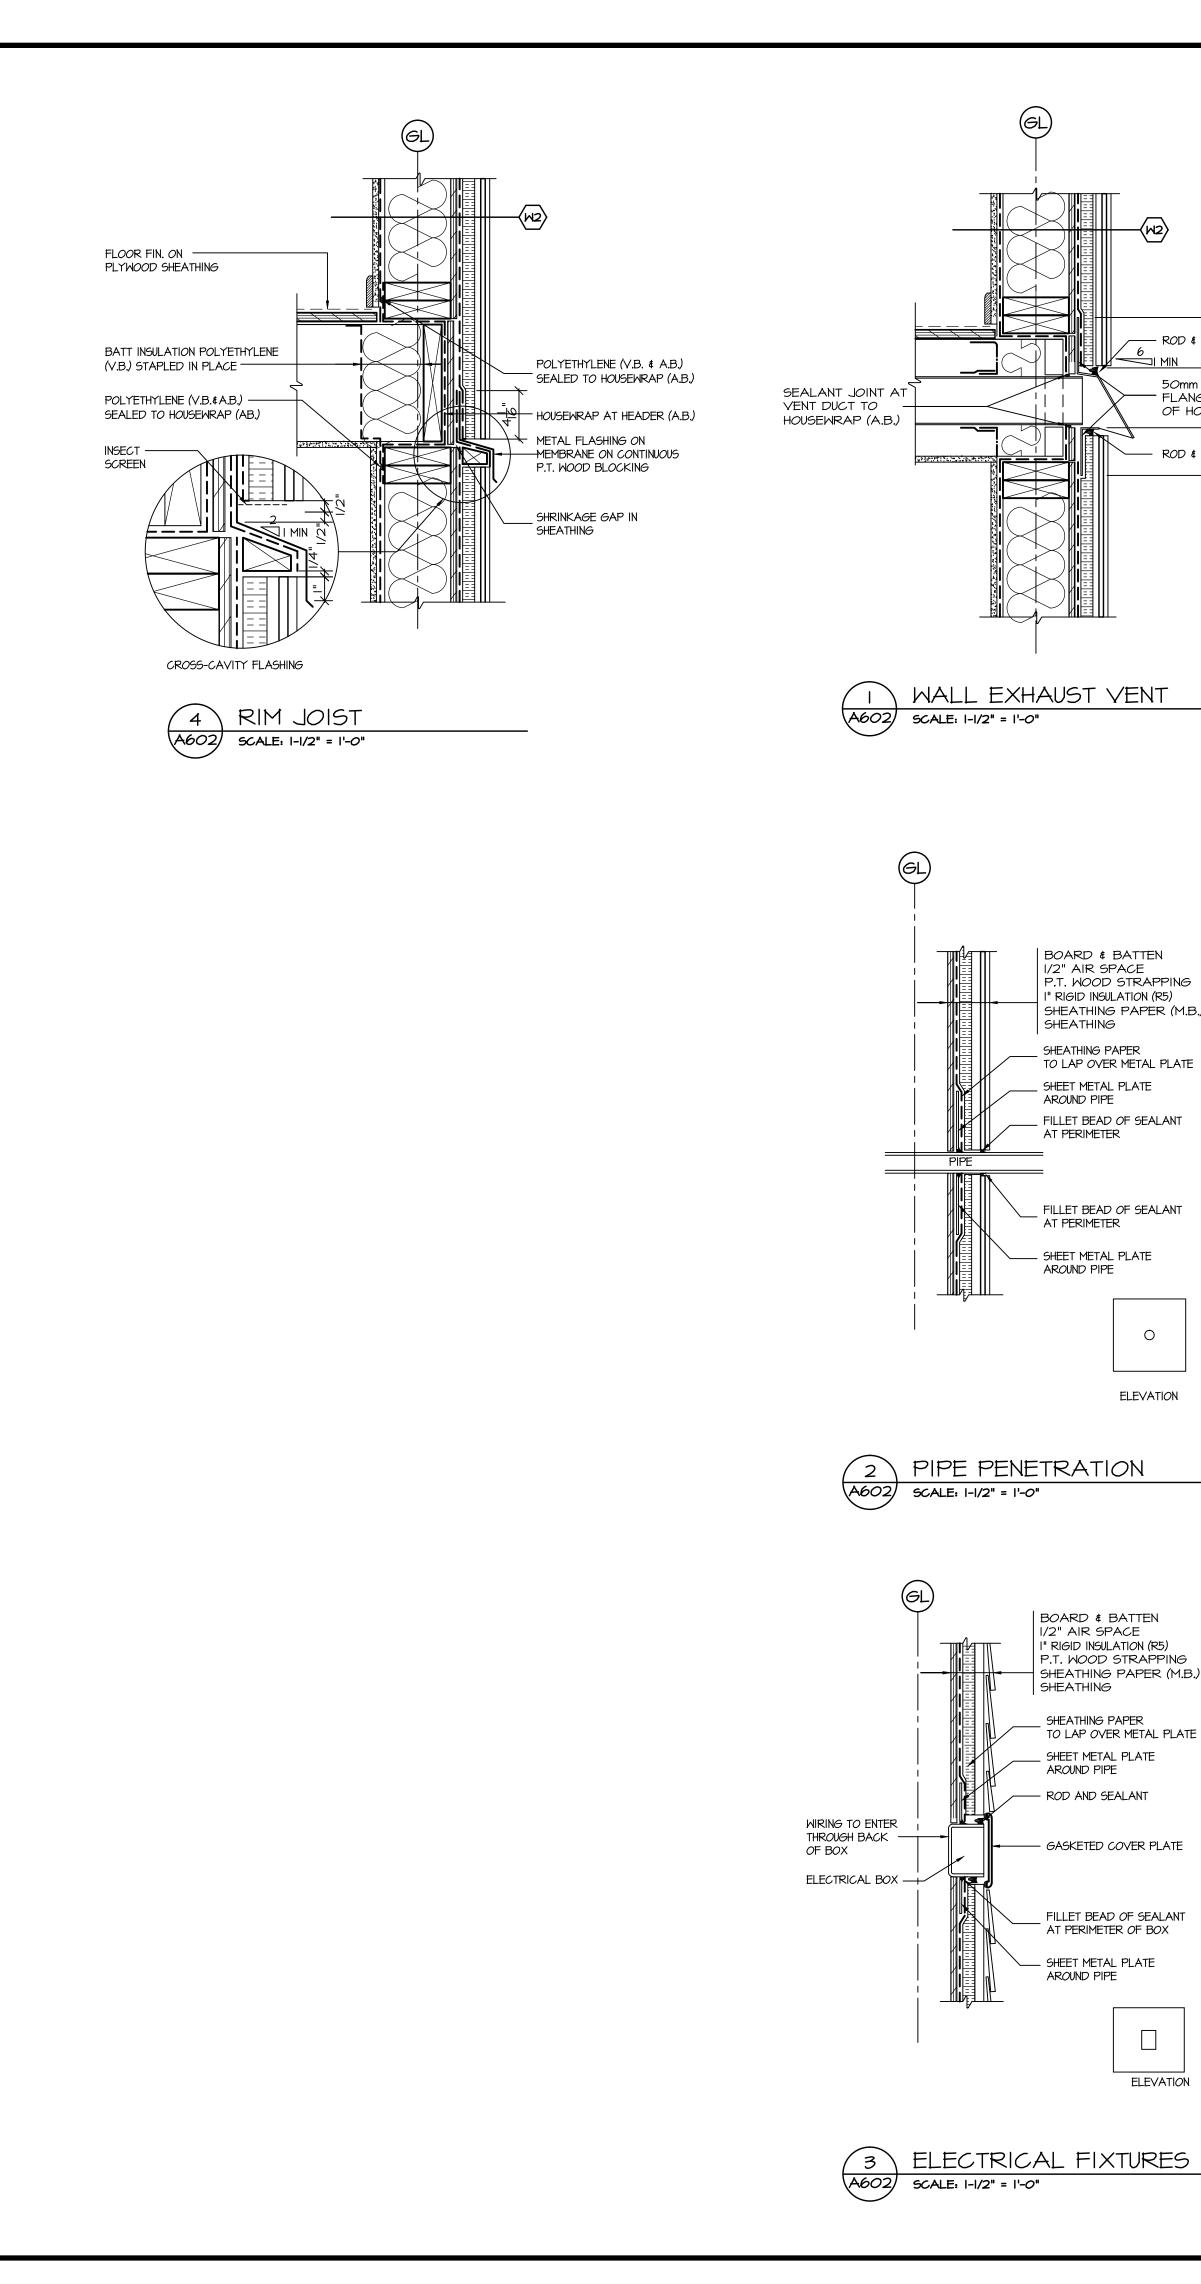

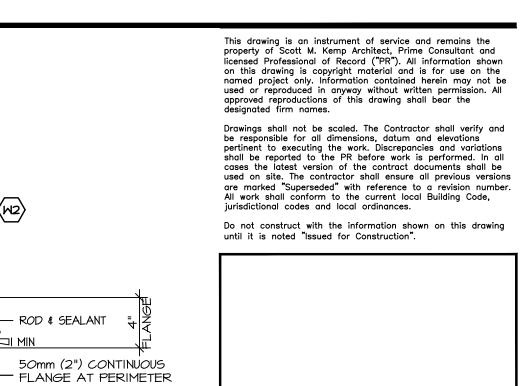

OF HOOD

BOARD & BATTEN 1/2" AIR SPACE P.T. WOOD STRAPPING I" RIGID INSULATION (R5) SHEATHING PAPER (M.B.)

SHEATHING

SHEATHING PAPER

SHEET METAL PLATE AROUND PIPE

BOARD & BATTEN I" RIGID INSULATION (R5) P.T. WOOD STRAPPING SHEATHING PAPER (M.B.)

SHEATHING PAPER

\_\_ SHEET METAL PLATE AROUND PIPE

— GASKETED COVER PLATE

\_\_ FILLET BEAD OF SEALANT AT PERIMETER OF BOX

**ELEVATION** 

\_ SHEET METAL PLATE AROUND PIPE

TO LAP OVER METAL PLATE


SHEATHING

AT PERIMETER

TO LAP OVER METAL PLATE

\_ FILLET BEAD OF SEALANT

- ROD & SEALANT

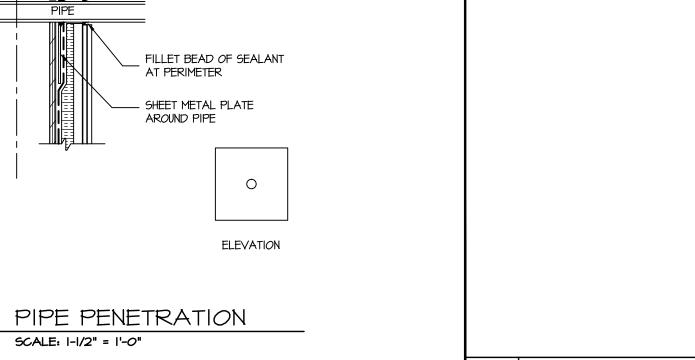

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REMARKS


NOV 22/17 ISSUED FOR REVIEW


DRAWING REVISIONS / ISSUES

PROJECT MALAHAT MULTIPURPOSE CULTURAL CENTRE Malahat, BC

DRAWING TITLE DETAILS


DRAWN ML DATE AUG/IT CHK'D SK JOB No. DESIGN DRAWING No. CHK'D \_ A602 SCALE AS SHOWN

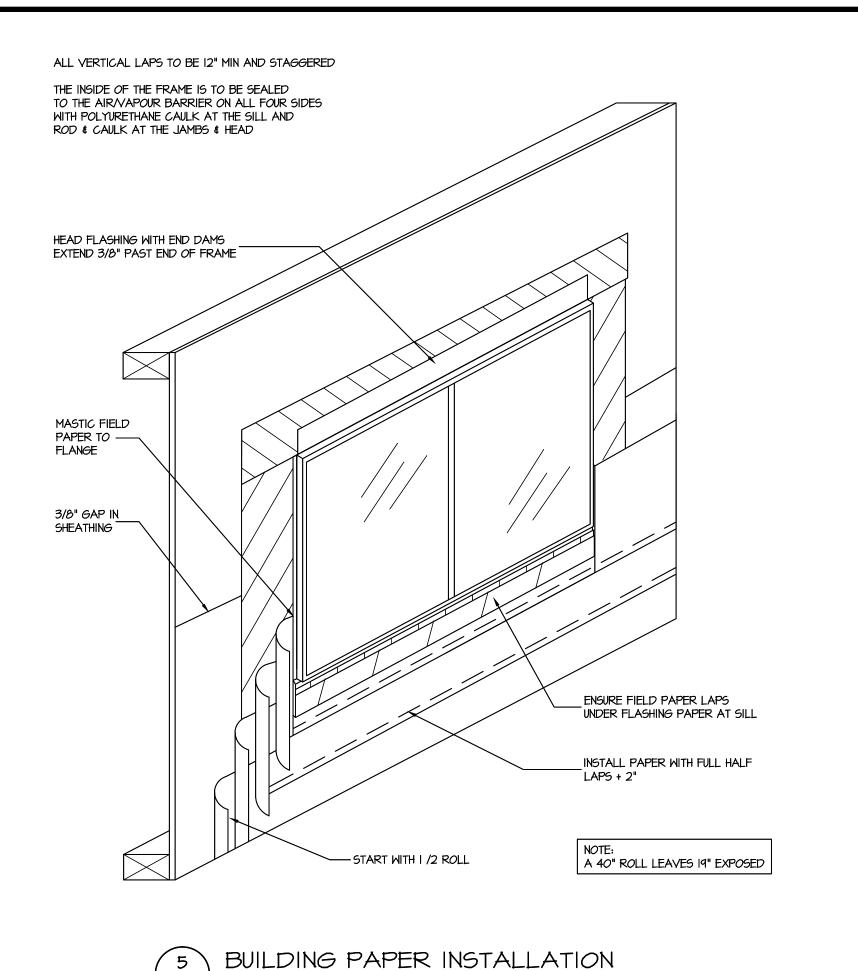

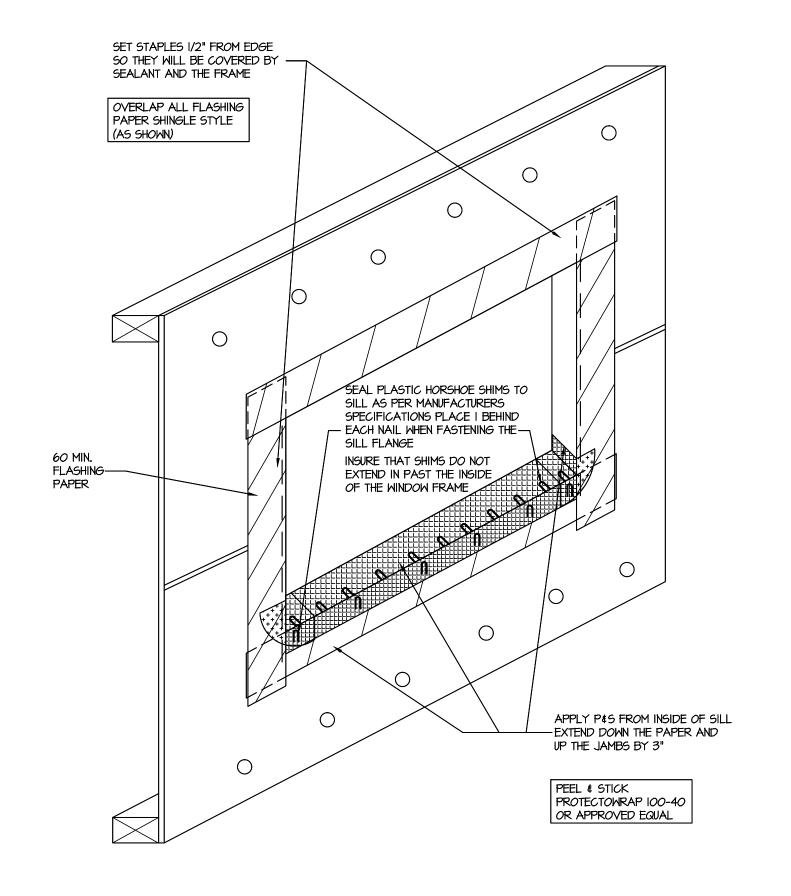



SCALE: |-|/2" = |'-0"


PEEL & STICK & FLASHING PAPER

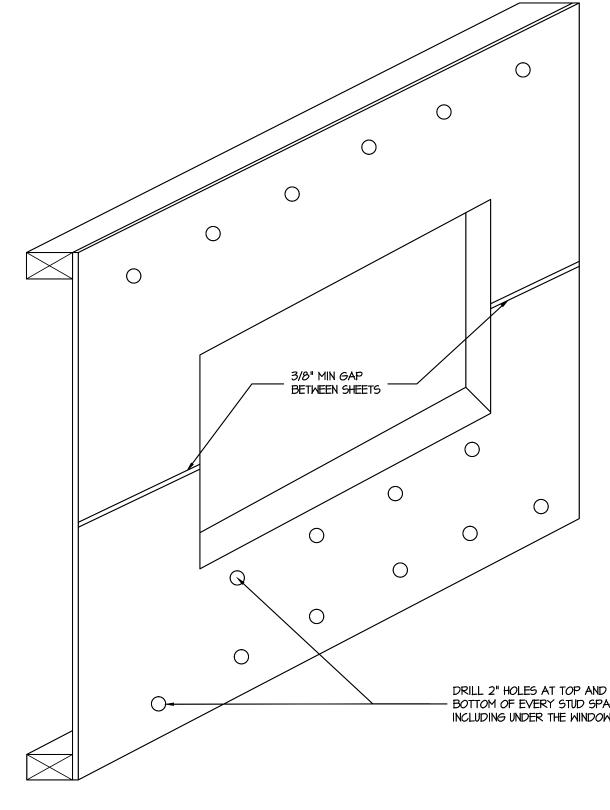


SCALE: |-|/2" = |'-0"

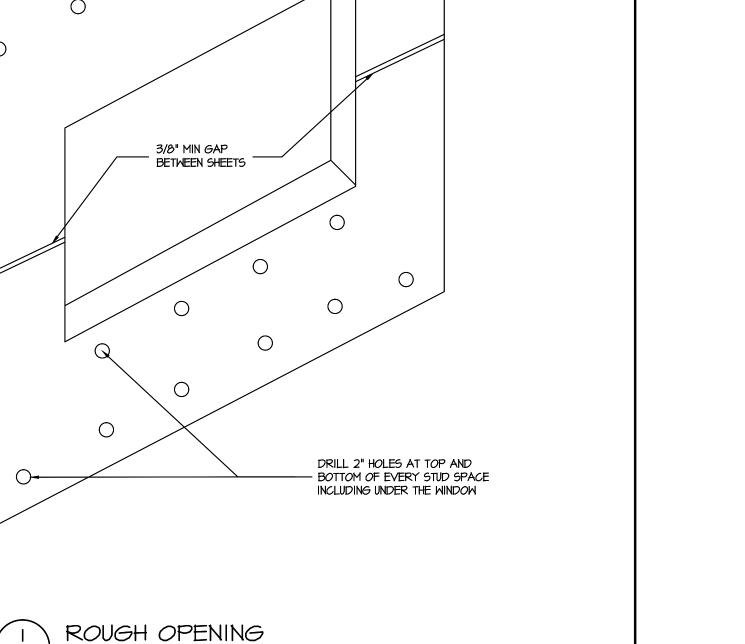

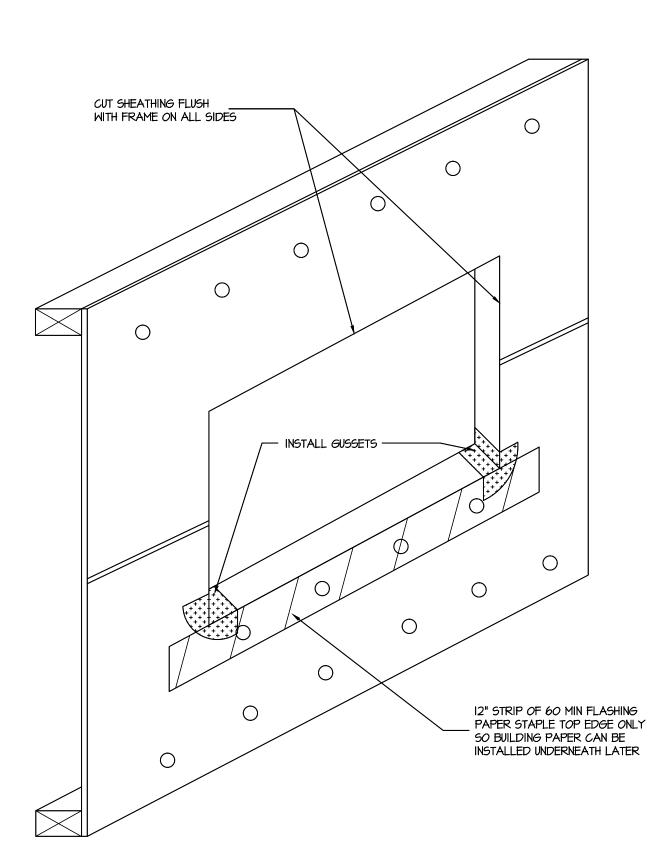

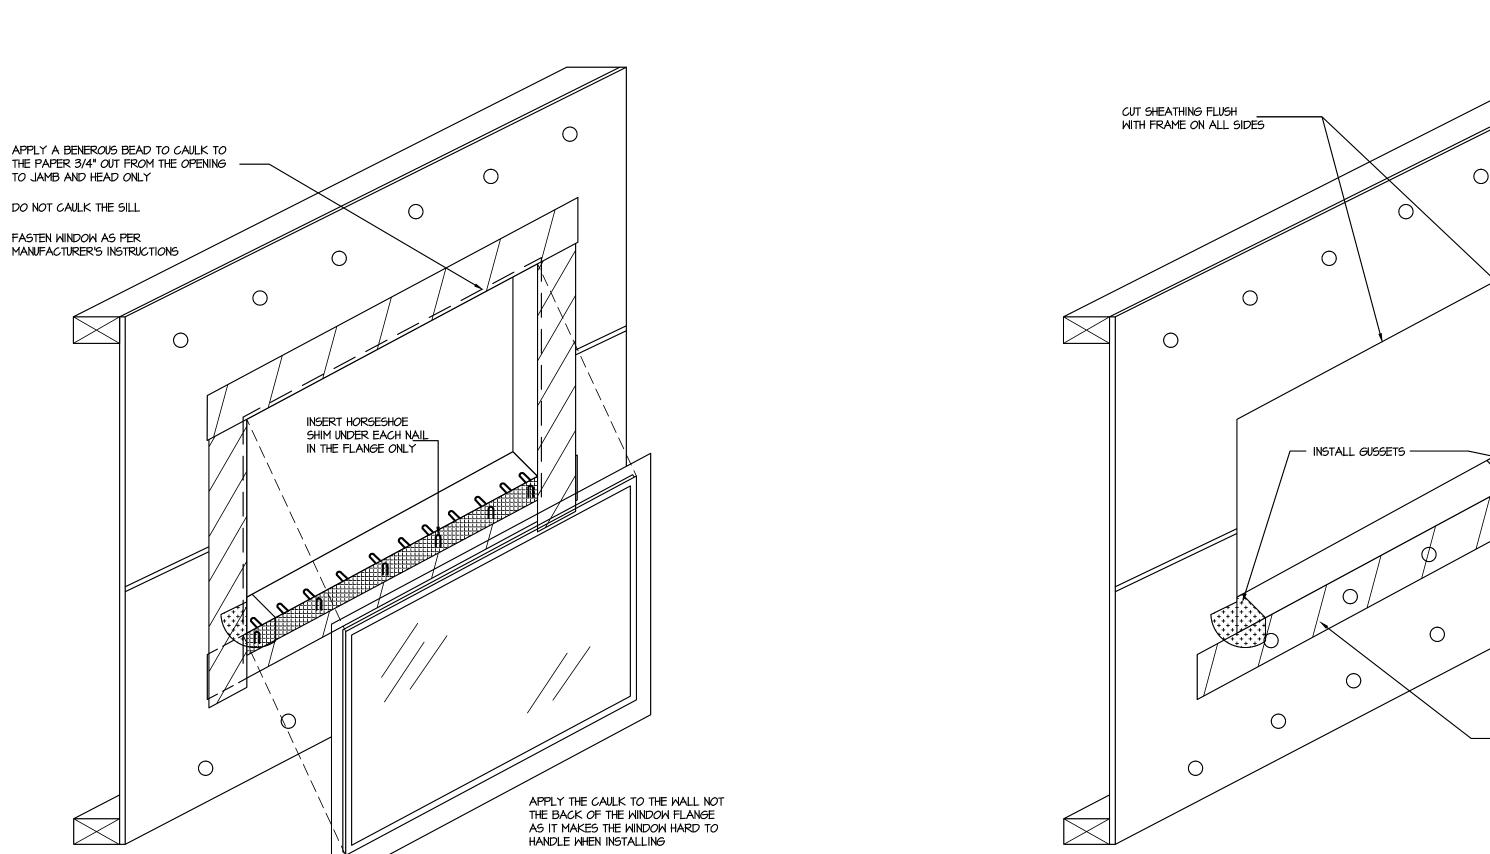

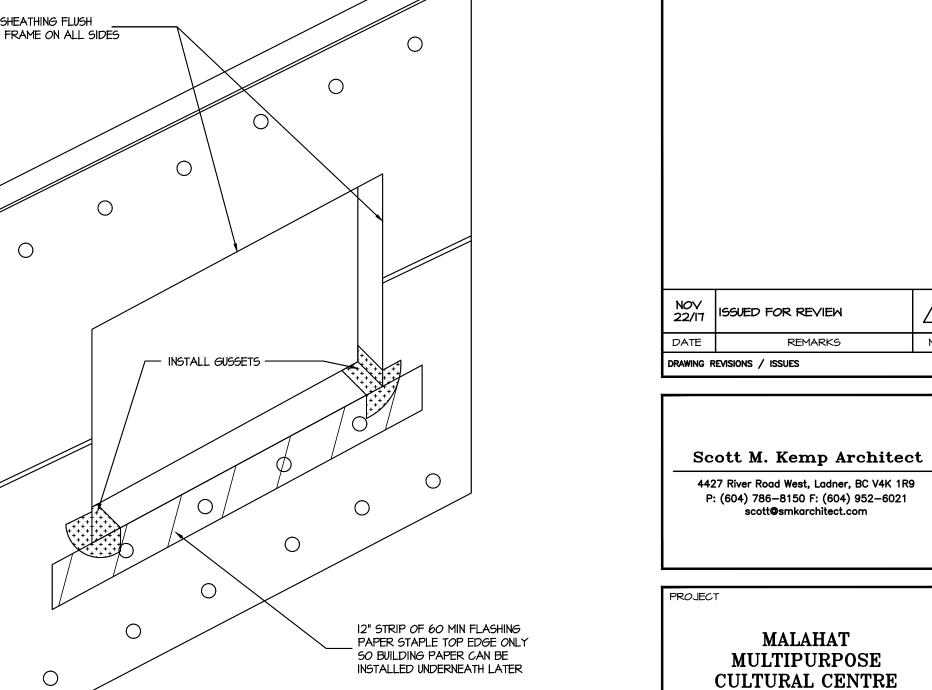

SILL FLASHING PAPER & GUSSETS

SCALE: |-|/2" = |'-0"

WINDOW INSTALLATION SEQUENCES

DATE AUG/IT CHK'D SK JOB No. DESIGN A603 CHK'D \_ SCALE AS SHOWN


REMARKS

MALAHAT

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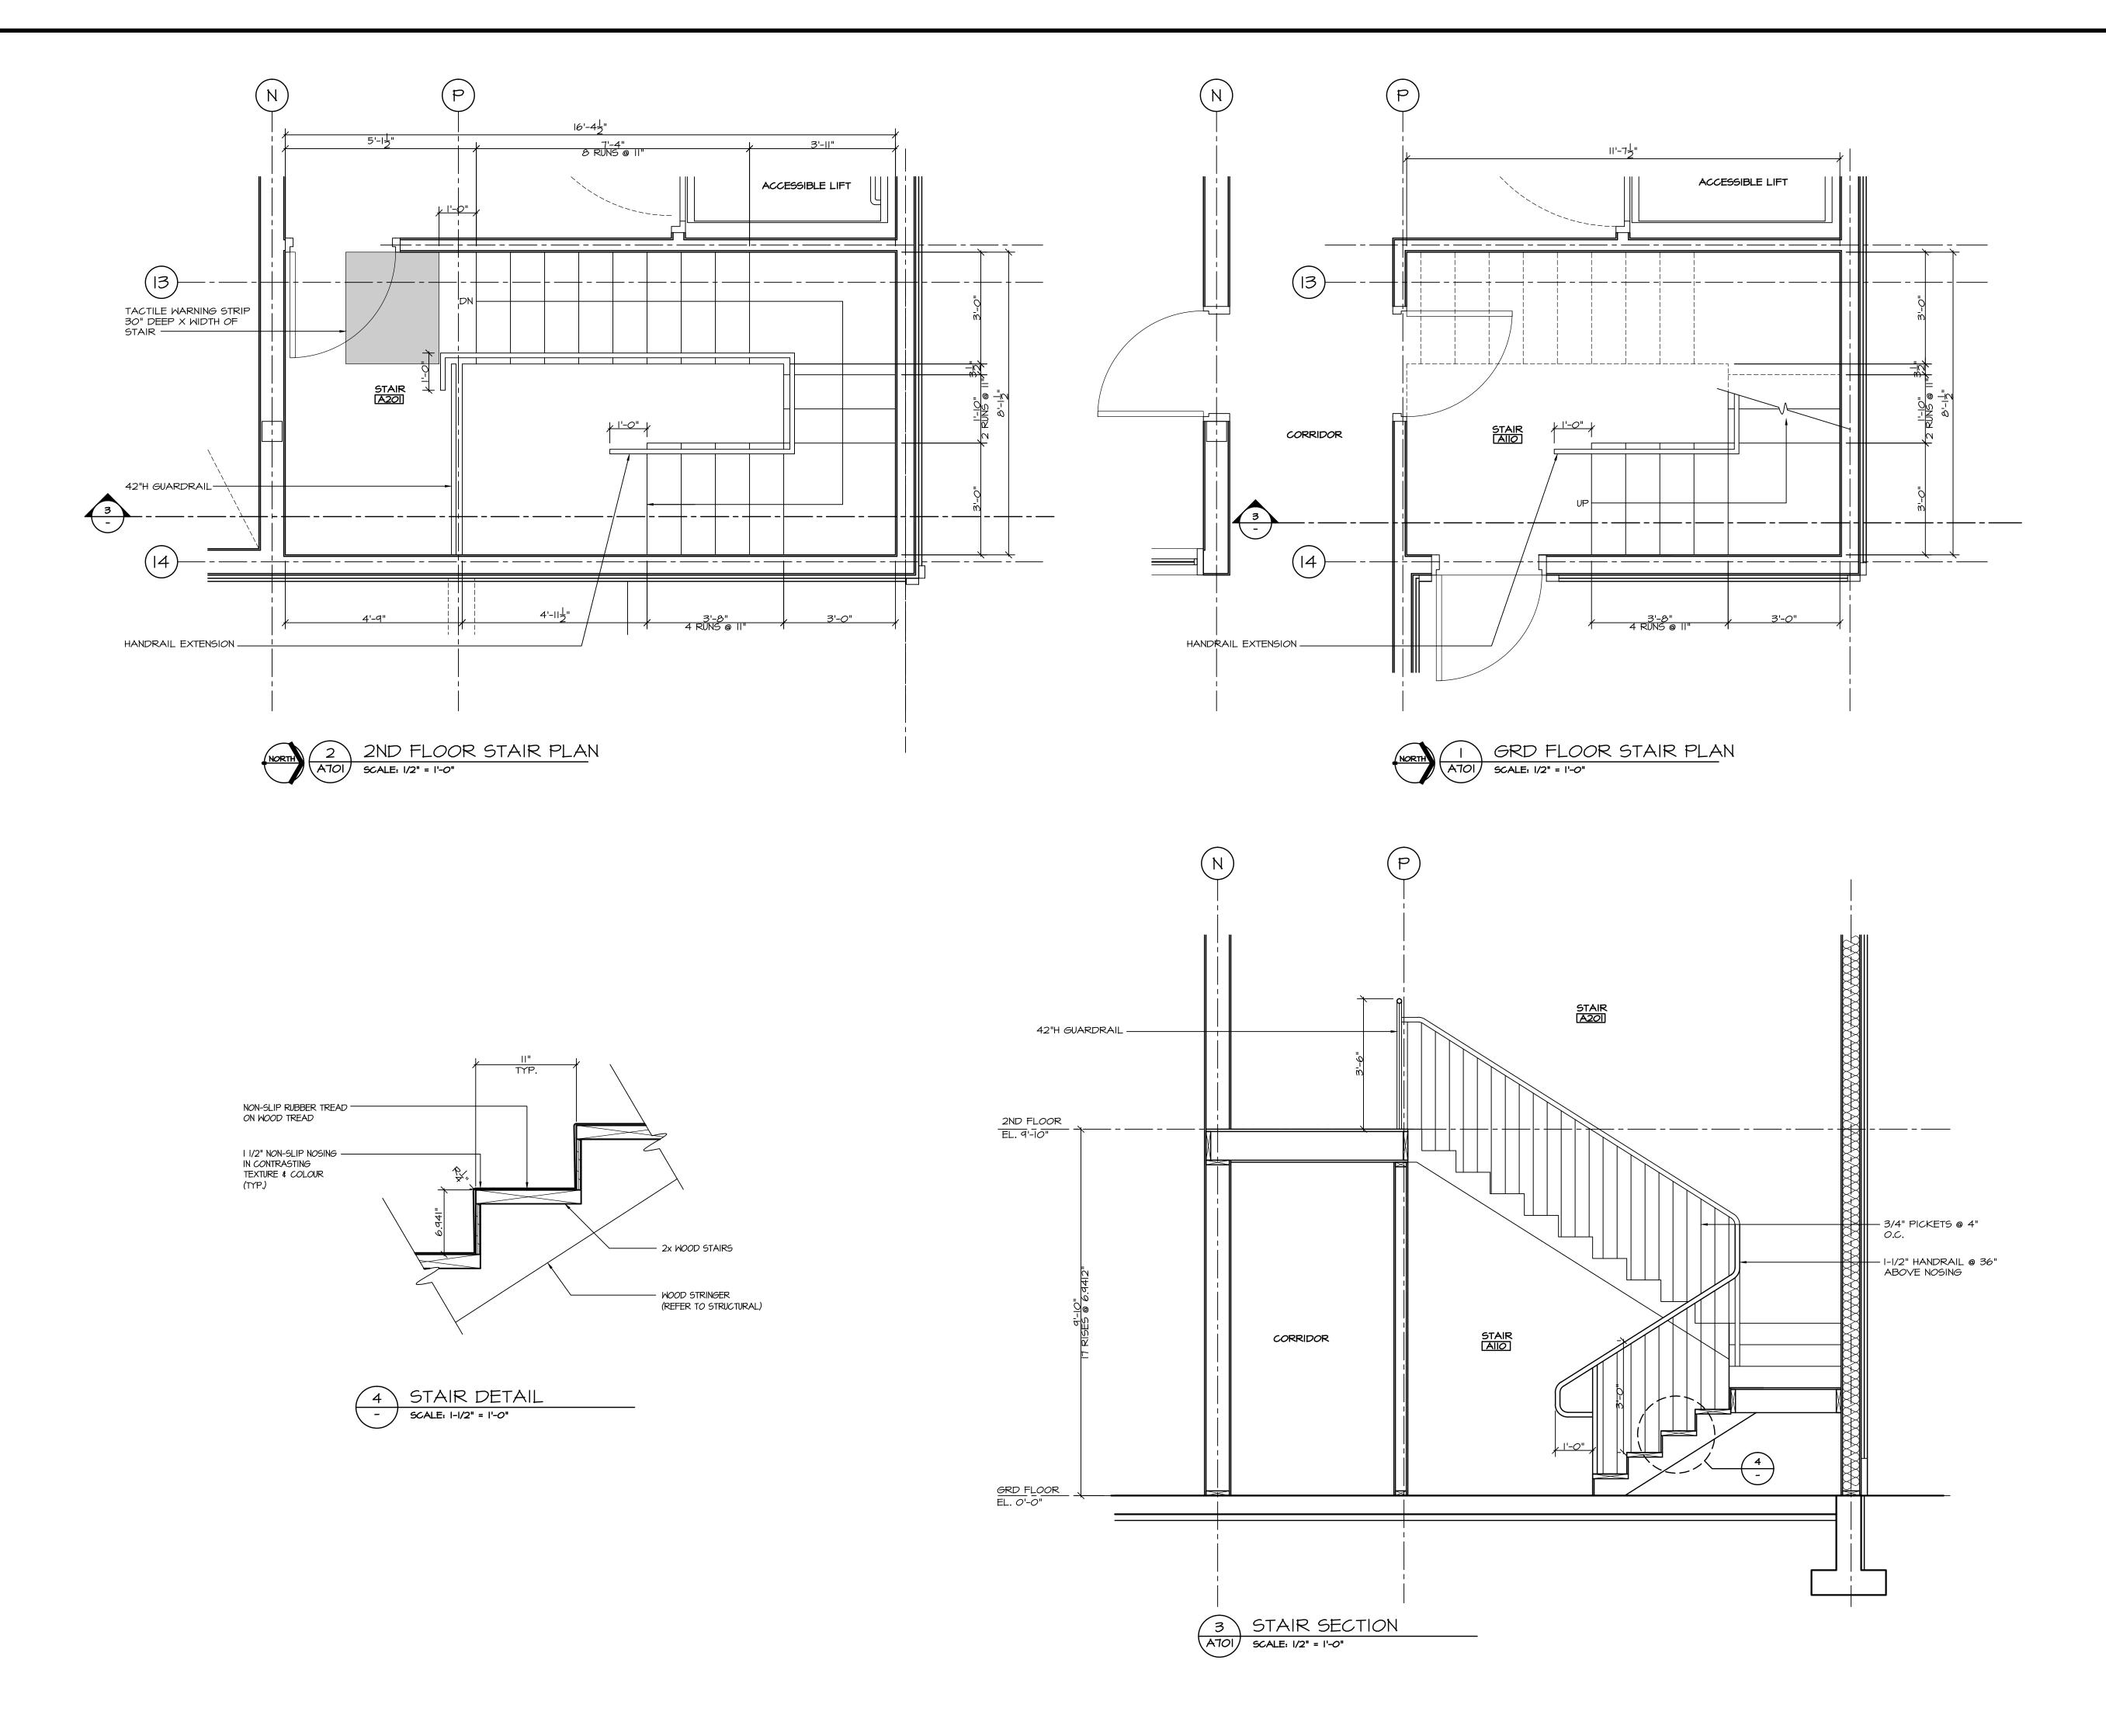
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BUILDING PAPER INSTALLATION/ STRAP VENTING UNDER SILL SCALE: 1-1/2" = 1'-0"

WINDOW INSTALLATION SCALE: I-I/2" = I'-0"

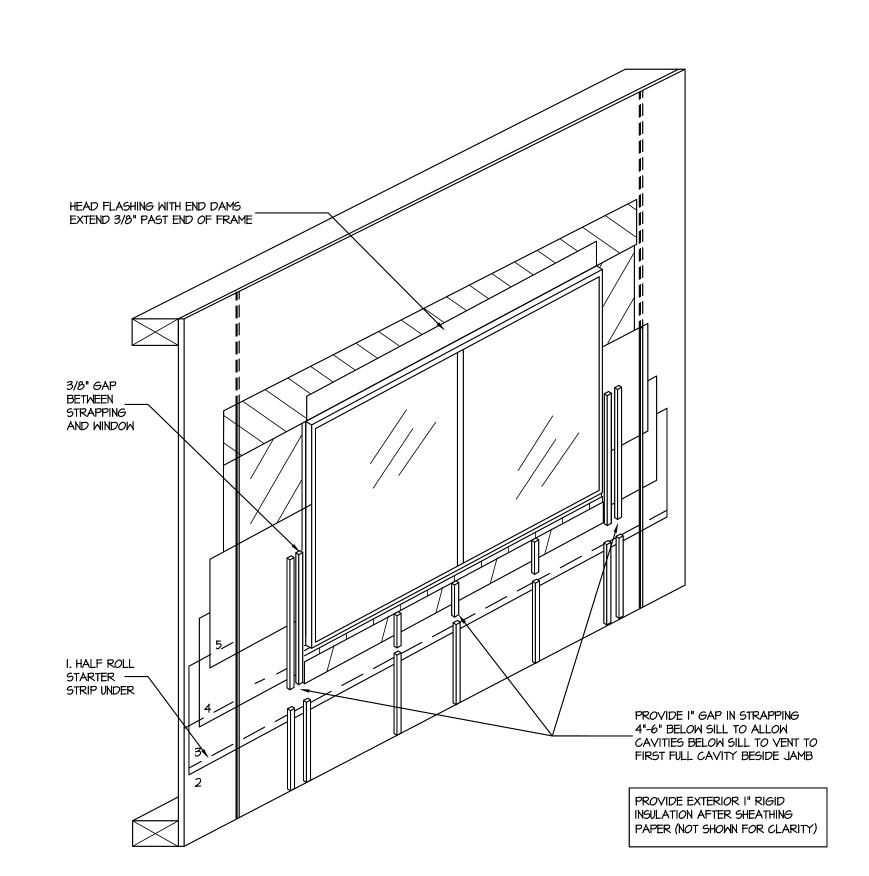

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Scott M. Kemp Architect

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PROJECT

MALAHAT
MULTIPURPOSE
CULTURAL CENTRE

Malahat, BC

DRAWING TITLE

STAIR PLANS, SECTION

AND DETAIL

DRAWN ML

CHK'D SK

DESIGN

DRAWING NO.

CHK'D \_

SCALE AS SHOWN

DATE AUG/I7

AUG/I7

AVGING NO.

A 701

							R	OOM	FII	NISH	l SC	CHE	DULE	:	
			F	LOC	R		BASE		MAL	LS		C	EILING		LEGEND:  NOTES:  V.F. = SOLID SHEET VINYL FLOORING  I. ALL INT. EXPOSED MECH./PLUMB. PIPINGS, DUCTWORKS,
		_ _ _ "·	CONC.	Щ	COURT FLOOING	3.	щ	. GMB	H,			Š		CLG.	CONC. = CONCRETE  R.B. = 4" RUBBER BASE  PT. = PAINT  G.C. = GYPSUM BOARD CEILING TO U/S OF TRUSSES  C.C. = CEDAR DECKING (EXPOSED STRUCT.)  TBAR = 2X4 T-BAR CEILING
FLR. NO.	ROOM NAME		8	#	3	R.B.	11	P.	TILE		0.0	33		HT.	REMARKS
MIOI	MAITING	•				•		•				•			
MIOI	A VESTIBULE	•				•		•				•			
MIO	RECEPTION	•				•		•				•			
MIO	2A STORAGE	•				•		•				•			
MIOS	B EXAM ROOM #I	•				•		•				•			
MIO	ACCESSIBLE TOILET	L		•		┸	•	•	•		$\perp$	•			
	OFFICE	•				•		•				•			
	OFFICE	•				•		•				•			
	EXAM ROOM #2	•				•		•				•			
	OFFICE	•				•		•							
	FOOT CARE					•		•							
MIIO		•				•		•				•			
MIII	LAUNDRY	•				•		•							
MII2		•				•		•							
MII3		•				•		•			•			8'-0"	O HR. FIRE RATED ROOM WITH GWB CEILING AT 8'-O". PROVIDE AIR TIGHT ROOM. SEAL AND CAULK ALL PENETRATIONS  I HR. FIRE RATED ROOM. PROVIDE 5/8" TYPE 'X' GWB ON CEILING. SEAL AND CAULK ALL PENETRATIONS W
MII4			•			•		•			•			8'-0"	APPROVED FIRE SEALANT. PROVIDE FIRE RETARDANT PLYWOOD FOR EQUIPMENT BACKING
	A KITCHENETTE	•				•		•			-				
	MALE TOILET	•				+			•						
MII6 0 MII7		╀				•		•							
MII7 MII8		•				+									
<b>—</b>	A STORAGE DENTIST	-				+-									
S DIOI		•				+									
₩	2 3-5	•				•		•							
	3   3-5 TOILET	H				╀			•						
	STORAGE	•				+									
	INFANT/TODDLERS	•				-									
	KITCHENETTE	•				-		•							
DIO		<del>                                     </del>		•		+						•			
	B LAUNDRY	•		<u> </u>		1.	-	•				•			
	1 M/E		•			•		•			•			8'-0"	I HR. FIRE RATED ROOM. PROVIDE 5/8" TYPE 'X' GWB ON CEILING. SEAL AND CAULK ALL PENETRATIONS W/ APPROVED FIRE SEALANT. PROVIDE FIRE RETARDANT PLYWOOD FOR EQUIPMENT BACKING
	ENTRANCE/LOUNGE	•				•		•							APPROVED FIRE SEALANT. PROVIDE FIRE RETARDANT PLIMOUD FOR EQUIPMENT BACKING
	2 OFFICE	•				•		•				•			
	3 HALLWAY	•				1.		•							
	MULTI-GAME COURT				•	1		•				•			
	MALE			•		1	•		•		•			9'-0"	
	JANITOR	•				•		•			•			9'-0"	O HR. FIRE RATED ROOM WITH GWB CEILING AT 8'-O". PROVIDE AIR TIGHT ROOM. SEAL AND CAULK ALL PENETRATIONS
	FEMALE			•			•		•		•			9'-0"	
AlO	STORAGE	•				•		•			•			9'-0"	
Alo	KITCHEN	•				•		•			•			9'-0"	
Alo	IA PANTRY	•				•		•			•			9'-0"	
11.5	10 14/5	1		1		1_								4, 4,	I HR. FIRE RATED ROOM. PROVIDE 5/8" TYPE 'X' GWB ON CEILING, SEAL AND CAULK ALL PENETRATIONS W/

AIO9B M/E

Allo STAIR

A201 STAIR

A203 H/C TOILET

A203 MULTI-PIRPOSE ROOM

A202 HALLWAY

I HR. FIRE RATED ROOM. PROVIDE 5/8" TYPE 'X' GWB ON CEILING. SEAL AND CAULK ALL PENETRATIONS W APPROVED FIRE SEALANT. PROVIDE FIRE RETARDANT PLYWOOD FOR EQUIPMENT BACKING

SEE DRAWING A501 FOR STAIR FINISHES

SEE DRAWING A501 FOR STAIR FINISHES

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NOY 22/17	ISSUED FOR REVIEW	<u>_</u>
DATE	REMARKS	NO.
DRAWING F	REVISIONS / ISSUES	

Scott M. Kemp Architect

4427 River Road West, Ladner, BC V4K 1R9 P: (604) 786-8150 F: (604) 952-6021 scott@smkarchitect.com

PROJECT

MALAHAT MULTIPURPOSE CULTURAL CENTRE

DRAWING TITLE


ROOM FINISH SCHEDULE

DRAWN	ML	DATE AUG/IT
CHK'D	5K	JOB No
DESIGN		DRAWING No.
CHK'D	-	A801
SCALE	AS SHOWN	


	NO.	DOOR TYPES RM NAME	W.	H.	TH.	TYPE	MAT'L	FINISH	TYPE	FRAME MAT'L		CLOSER	STOP PPIVACY I OCYGET	PASSAGE LATCHSET STORERM LOCKSET	TRANCE LOCA	PUSH & PULL HANDLE WEATHERSTRIP, THRESHOLD DOOR BOTTOM OFFICE LOCKSET	PANIC HARDWARE	TLUSTIDOL I ASTRAGAL	VISION PANEL	IC STRIKE	LEGEND: ALUM. = ALUMINUM P.S. = PRESSED STEEL ANOD. = ANODIZED ALUM. MTL. = METAL STL. = STEEL FAC. = FACTORY FINISH S.C.W. = SOLID CORE WOOD PT. = PAINT  NOTES:  1. DOOR HARDWARE TYPE & FINISH TO BE APPROVED BY ARCHITECT. 2. HARDWARE TO COMPLY WITH CURRENT EDITION OF B.C.B.C. INCLUDING REQUIREMENTS FOR DISABLED. 3. SECURITY HARDWARE (SEE ELECTRICAL DRAWINGS) 4. RATED DOORS TO COMPLY TO N.F.P.A. 80 STANDARDS. 5. ALL DOOR HANDLES SHALL BE LEVER TYPE HANDLE AND BEVELLED.  REMARKS	SAFETY GLASS ———————————————————————————————————
	MIOIA	VESTIBULE	2X3'-O"	7'-0"	2"	Α	ALUM.	ANOD.	Α	ALUM.	ANOD.	•			•	•	•	•	•			
	MIOIB	WAITING	2X3'-0"	7'-0"	2"	Α	ALUM.	ANOD.	Α	ALUM.	ANOD.	•	•		•	•		•	•			-3
_		MAITING	2X3'-0"	7'-0"	2"	A		ANOD.		ALUM.	ANOD.	_	_		•	•	•		•			
<del> </del>	-	VESTIBULE	2X3'-O"	7'-0"	2"	A	+	ANOD.		ALUM.			_		•		-		•			
-		RECEPTION	2'-10"	7'-0" 7'-0"	1-3/4"	+	S.C.W.		В	P.S.	PT.		•	+ + -	•		+			+		
<u> </u>		STORAGE  EXAM ROOM #I	2'-IO" 2'-IO"	7'-0"	I-3/4"		5.C.W.		B	P.S.	PT.		•	•								
_	-	EXAM ROOM #I	1'-0"	2'-0"	1-3/4"	F	MD.	PT.	В	P.S.	PT.	+	•									
		ACCESSIBLE TOILET	2'-10"	7'-0"	1-3/4"		S.C.W.		В	P.S.	PT.		• •									
-		ACCESSIBLE TOILET	1'-0"	2'-0"	1-3/4"	_	MD.	PT.	В	P.S.	PT.		• •									
<u> </u>		OFFICE	2'-10"	7'-0"	1-3/4"	В	S.C.W.		В	D.G.	PT.		•		•		1			11		
<b>-</b>		OFFICE	2'-10"	7'-0"	1-3/4"	+	S.C.M.	1		P.S.	PT.	-	•		•							
	МІОТ	EXAM ROOM #2	2'-10"	7'-0"	1-3/4"	В	S.C.W.	PT.	В	P.S.	PT.		•	•								
		OFFICE	2'-10"	7'-0"	1-3/4"		S.C.W.		В	P.S.	PT.		•		•							
_		FOOT CARE	2'-10"	7'-0"	1-3/4"		S.C.M.			P.S.	PT.		•	•								
<u> </u>		OFFICE	2'-10"	7'-0"	1-3/4"	+	S.C.W.			P.S.	PT.	+	•		•		1	$\perp$		$\bot \bot$		SAFE <sup>-</sup>
<b>—</b>		LAUNDRY	2'-10"	7'-0"	1-3/4"	+	S.C.W.			P.S.	PT.		•		<b> </b>		1	+		+		GLASS
_		OFFICE	2'-IO" 2'-IO"	7'-0"	I-3/4"		5.C.M.			P.S.	PT.		•		•						PROVIDE AIR TIGHT DOOR	
-		JANITOR ELECTRICAL	2'-10"	7'-0"	2"	+	S.C.W.	PT.		P.S.	PT.		•	•							TROYIDE AIR HOTT DOOR	
-		KITCHENETTE	2'-10"	7'-0"	1-3/4"		5.C.W.			P.S.	PT.		•									
_		KITCHENETTE	2'-10"	7'-0"	1-3/4"	+	5.C.M.			P.S.	PT.		•	-								
<b>—</b>		MALE TOILET	2'-10"	7'-0"	1-3/4"	+	5.C.W.			P.S.	PT.		• •	+ + -	+		+ +	+				
<u> </u>	-	MEETING	2'-10"	7'-0"	1-3/4"	+	S.C.W.			P.S.	PT.	+	•	•			† †	+				
	MII7	FEMALE TOILET	2'-10"	7'-0"	1-3/4"		S.C.W.		В	P.S.	PT.		• •									
00-	MII8	DENTIST OFFICE	2'-10"	7'-0"	1-3/4"	В	S.C.W.	PT.	В	P.S.	PT.		•		•							
$\sim$		STORAGE DENTIST	2'-10"	7'-0"	1-3/4"		S.C.W.			P.S.	PT.	-	•	•								
ನ ⊦		VESTIBULE	2X3'-0"	7'-0"	2"	+	ALUM.			ALUM.	ANOD.	-			•	•	+ +			-		
$\sigma$ $\vdash$	DIO2A		2X3'-0"	7'-0"	2"	+	ALUM.			ALUM.	ANOD.	-		1-	•				•			
_		CLOSET	2X2'-2"	7'-0" 7'-0"	1-3/4"		S.C.M.			P.S.	PT.	_	•	•								
_	DI02C	3-5 TOILETS		7'-0"	2" I-3/4"	+	ALUM. S.C.W.			ALUM. P.S.	PT.	-	•		•				•	<b>'</b>		
_		STORAGE	2'-10"	7'-0"	1-3/4"	-	5.C.M.			P.S.	PT.	-	•	-								
-		STORAGE	2'-10"	7'-0"	2"			PT.		P.S.	PT.		•									
<b>-</b>	+	KITCHENETTE	2'-10"	7'-0"	1-3/4"	+	5.C.W.			P.S.	PT.		•	+   •	•		+ +	+		++		
<u> </u>		STAFF/INFANT/TODDLERS TOILET	2'-10"	7'-0"	1-3/4"	+	S.C.M.			P.S.	PT.		• •									
	D108	LAUNDRY	2'-10"	7'-0"	1-3/4"	В	S.C.M.	PT.	В	P.S.	PT.		•	•								
	D109	M/E	2'-10"	7'-0"	2"			PT.		P.S.	PT.		•	•		•						
-		ENTRANCE	2X3'-0"	7'-0"	2"		ALUM.			ALUM.	ANOD.	_	-		•	•	_	•				
<b>-</b>		ENTRANCE	2X2'-IO"	7'-0"	2"	A	ALUM.			ALUM.	ANOD.	-		1	•	•			•			
-		ENTRANCE	2'-10"	7'-0"	2"	+	ALUM.			ALUM.	ANOD.	-	•	•			+ +	+		++		
<u> </u>		OFFICE OFFICE	2'-IO" 2'-IO"	7'-0"	I-3/4"		S.C.W.			P.S.	PT.		•									
-		HALLWAY	2'-10"	7'-0"	1-3/4"		5.C.M.			P.S.	PT.	-	•									
		MULTI-GAME COURT	2X3'-O"	7'-0"	2"		ALUM.			ALUM.	ANOD.		_		•	•		•				
Ī		MULTI-GAME COURT	2X3'-O"	7'-0"	2"	A	ALUM.			ALUM.	ANOD.	-			•	•	_	•				
-		MALE	2'-10"	7'-0"	1-3/4"	В	S.C.W.			P.S.	PT.	-	• •	,								
ļ	Al06	JANITOR	2X2'-8"	7'-0"	1-3/4"	C	S.C.M.	PT.	В	P.S.	PT.		•	•		•					PROVIDE AIR TIGHT DOOR	
	AIOT	FEMALE	2'-10"	7'-0"	1-3/4"	В	S.C.W.	PT.	В	P.S.	PT.		• •									
-		STORAGE	2'-10"	7'-0"	1-3/4"	+	S.C.W.			P.S.	PT.		•	•								
-		PANTRY	2'-10"	7'-0"	1-3/4"	+	S.C.W.			P.S.	PT.	-	•		•							
<b>⊢</b>	AIO9B		2'-10"	7'-0"	2"	+	MTL.	PT.		P.S.	PT.	-	•	•	+	•				++		
<b></b>		KITCHEN	2'-10"	7'-0"	1-3/4"	_	5.C.W.			P.S.	PT.	-	•	_	•		+			++		
-		KITCHEN		7'-0"	2"			PT.			PT.		_	•	•							
	AIIOA AIIOB		2'-IO" 2'-IO"	7'-0"	I-3/4"	+		PT.		P.S. P.S.	PT.	•		•		•					45 MIN. FIRE RESISTANCE RATING (PROVIDE RATING ON DOOR & FRAME)	
	-	STAIR	2'-10"	7'-0"	1-3/4"	+	+	PT.		P.S.	PT.		_								STATE TO THE TOTAL TO THE TOTAL OR DOOR & TRAIL	
∠¥ ⊦		H/C TOILET	2'-10"	7'-0"	1-3/4"		5.C.W.			P.S.	PT.		• •								45 MIN. FIRE RESISTANCE RATING (PROVIDE RATING ON DOOR & FRAME)	
$ ^{\mathrm{H}}$ $^{\mathrm{H}}$		LOUNGE		7'-0"	1-3/4"	+	S.C.W.			P.S.	PT.		•	•	+			-		+		

DOOR SCHEDULE:


### DOOR TYPES:

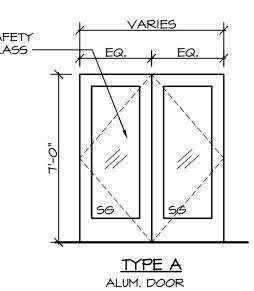



W SAFETY GLASS

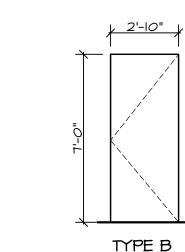


SOLID CORE WOOD DOOR

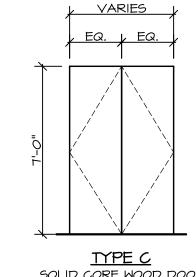

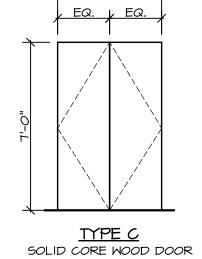


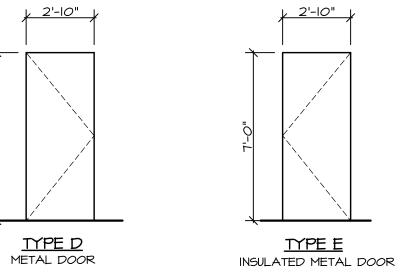

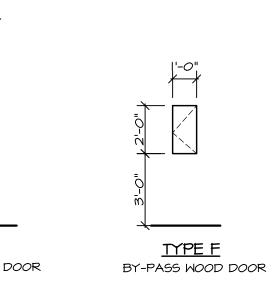





### DOOR FRAME TYPES:

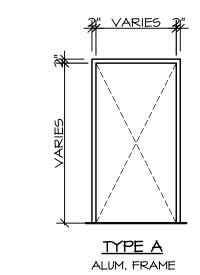

TYPE 6 ALUM. DOOR W/ SAFETY GLASS

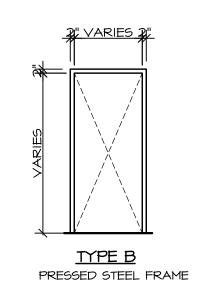

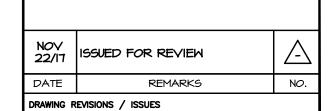

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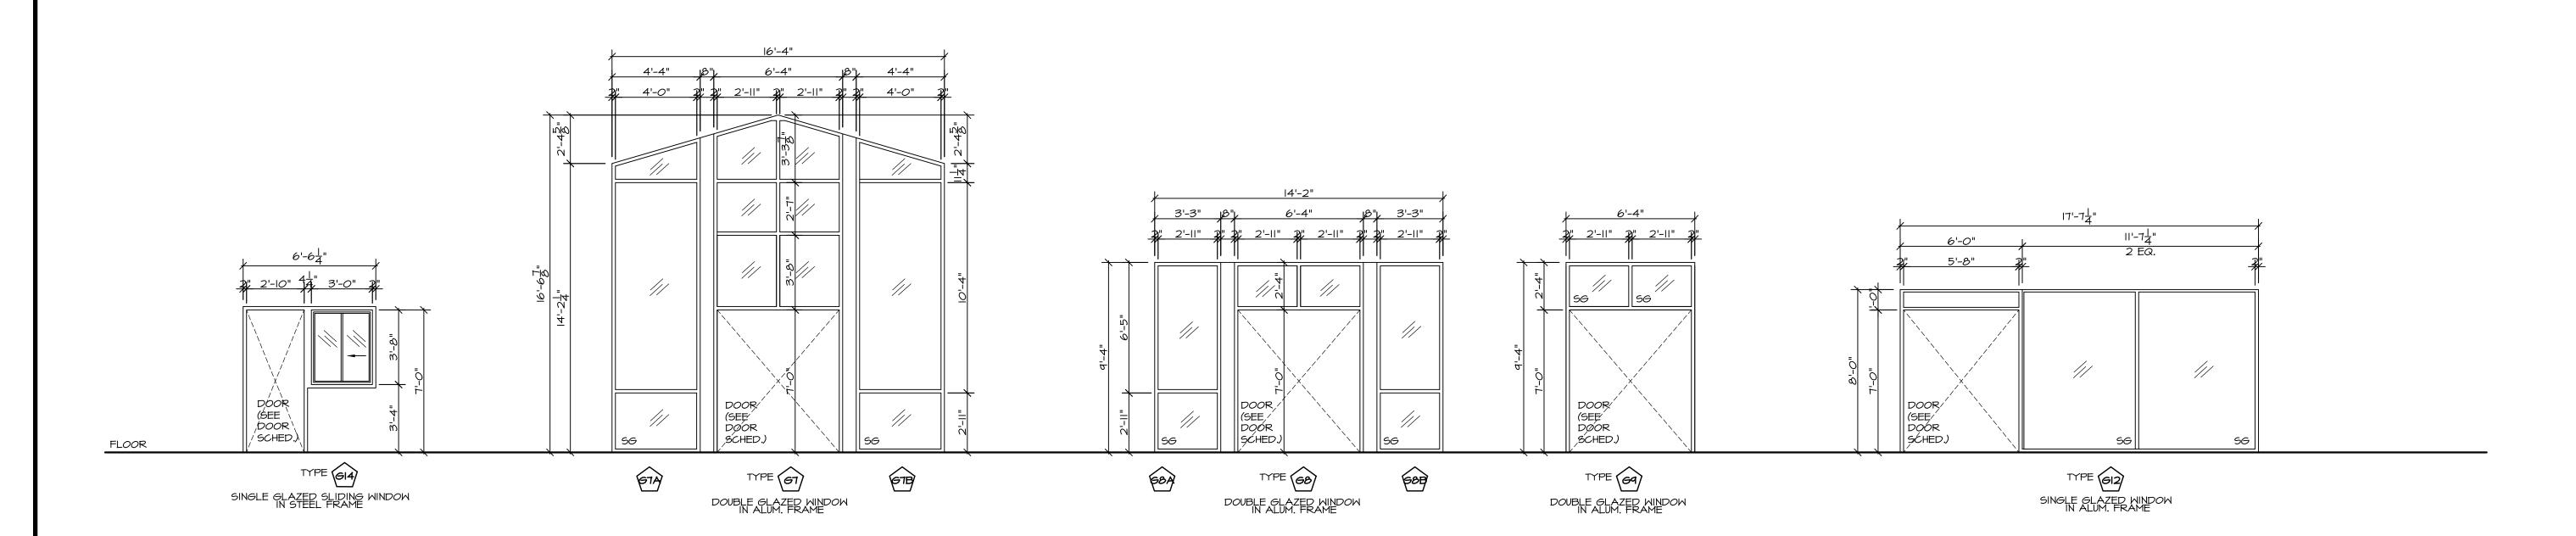
Scott M. Kemp Architect 4427 River Road West, Ladner, BC V4K 1R9 P: (604) 786-8150 F: (604) 952-6021 scott@smkarchitect.com

PROJECT MALAHAT MULTIPURPOSE CULTURAL CENTRE

DRAWING TITLE DOOR SCHEDULE, DOOR TYPE, DOOR FRAME TYPE

DRAWN	ML	DATE	AUG/IT
CHK'D	5K	JOB No.	-
DESIGN		DRAWING	∂ No.
CHK'D	-	A	802
SCALE	AS SHOWN		

### GLAZING SCHEDULE: -----2X4 WOOD TRIM (TYP.)----2ND FLOOR DOOR (SEE \ SCHED.) GRD FLOOR TYPE 62 TYPE 63 TYPE 64 TYPE 65 TYPE 66 TYPE 66A TYPE GIO TYPE GII) DOUBLE GLAZED WINDOW IN ALUM. FRAME DOUBLE GLAZED WINDOW IN ALUM, FRAME SINGLE GLAZED SLIDING WINDOW IN ALUM, FRAME DOUBLE GLAZED WINDOW IN ALUM, FRAME SINGLE GLAZED SLIDING WINDOW IN STEEL FRAME DOUBLE GLAZED WINDOW IN ALUM. FRAME DOUBLE GLAZED WINDOW IN ALUM. FRAME SINGLE GLAZED 45 MIN. FIRE RATED WINDOW



NOTES:

IN STEEL FRAME

- I. SHOP DRAWINGS FOR ALL WINDOWS SIGNED AND SEALED BY THE STRUCTURAL ENGINEER MUST BE SUBMITTED TO THE ARCHITECT FOR APPROVAL BEFORE INSTALLATION BEGINS.
- 2. THE WINDOWS MUST MEET STANDARDS AS DETERMINED USING THE TESTING STANDARDS LISTED IN BUILDING CODE
- 3. ANY LARGE MECHANICAL GRILLE OPENINGS ON EXTERIOR FACADES SHALL BE PREPARED AND FINISHED IN THE SAME MANNER AS THE WINDOW ASSEMBLIES
- 4. ALL WINDOWS ARE VIEWED FROM EXTERIOR OF BLDG OR ROOM
- 5. PROVIDE SAFETY GLASS (TEMPERED GLASS OR LAMINATED GLASS) FOR SECURITY AS INDICATED ON WINDOW TYPES (SG)
- 6. ALL EXTERIOR WINDOWS TO BE DOUBLE GLAZED LOW 'E' GLAZING TO MEET CURRENT STANDARDS
- 7. ALL INTERIOR WINDOWS TO BE SINGLE GLAZED GLAZING
- 8. PROVIDE SAMPLE TO ARCHITECT FOR COLOUR APPROVAL PRIOR TO
- 9. ALL WINDOWS SHALL BE ANODIZED ALUMINIUM FRAMED WINDOWS

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	1	
NOV 22/17	ISSUED FOR REVIEW	_
DATE	REMARKS	NO.
DRAWING	REVISIONS / ISSUES	
	·	

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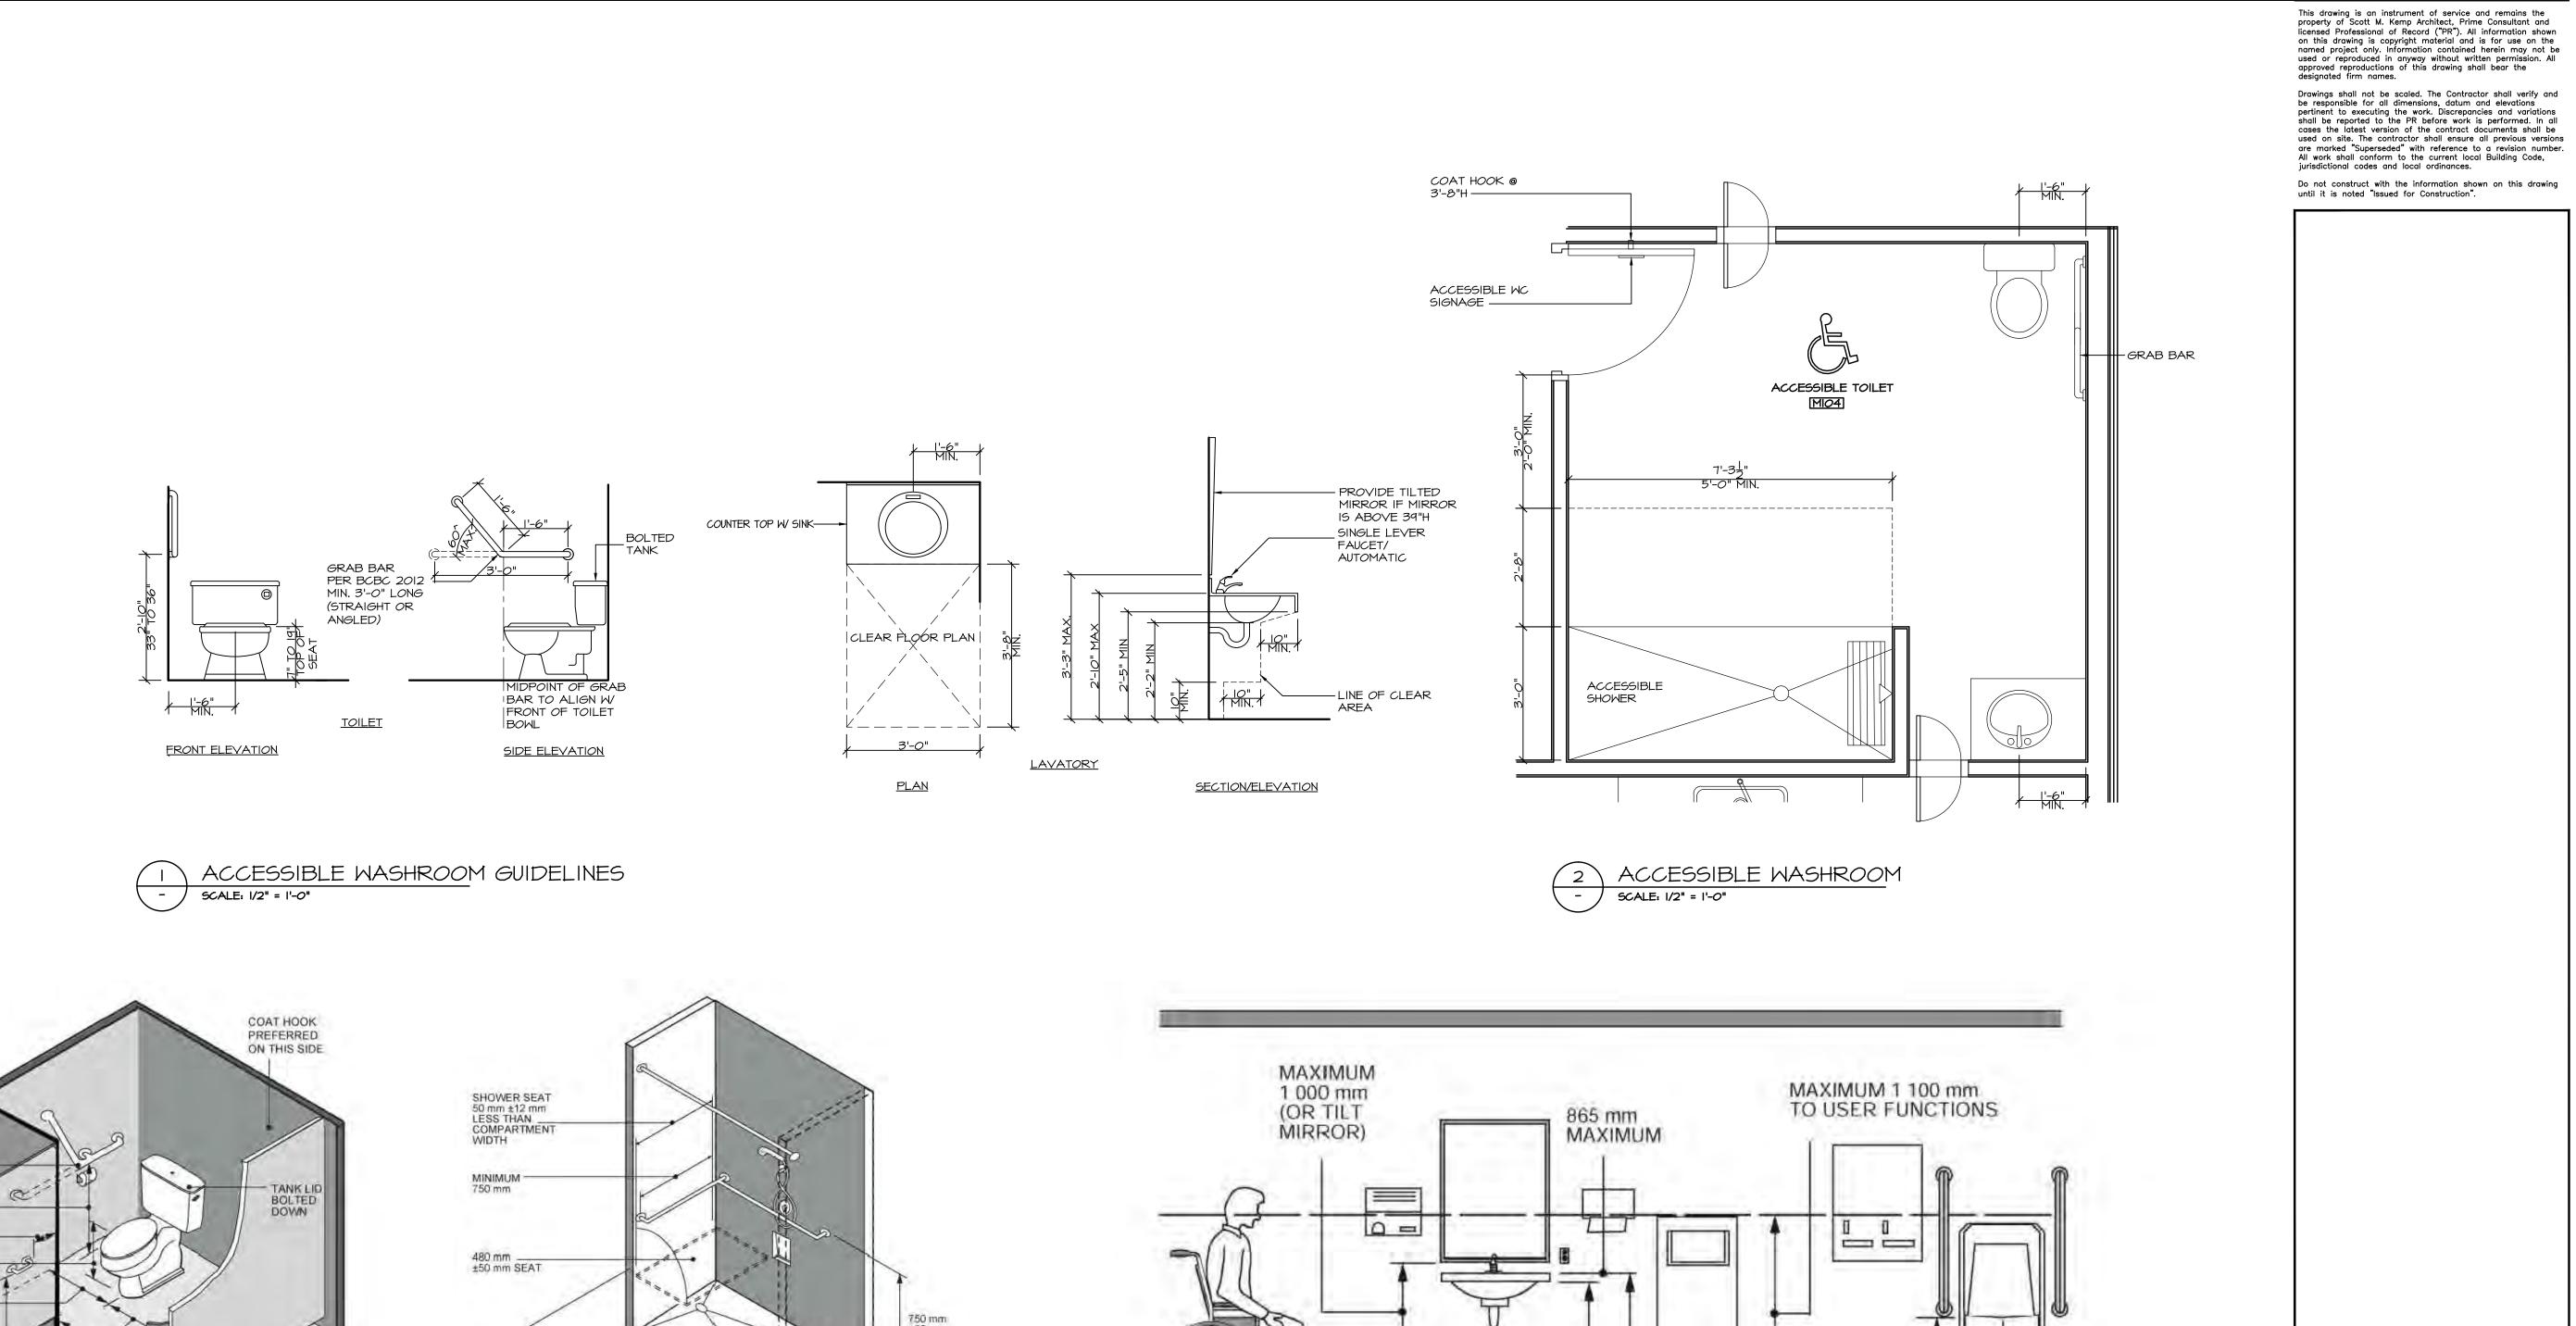
PROJECT MALAHAT

MULTIPURPOSE CULTURAL CENTRE

Malahat, BC

DRAWING TITLE GLAZING SCHEDULE

DATE AUG/17 CHK'D SK JOB No. DESIGN DRAWING No. **E08A** CHK'D \_ SCALE AS SHOWN



MINIMUM -

FIGURE 3.8.51. - Washroom Accessories

735 mm

500 mm -

±10 mm

GRAB BAR 450 mm x 450 mm x 120° or 900 mm

455 mm — ±25 mm TO SEAT

FIGURE 3.8.48. - Toilet Compartment

455 mm ±25 mm

> MINIMUM 1 500 mm

CLEAR FLOOR AREA

FIGURE 3.8,54. - Shower Compartment

880 mm ±40 mm

450 mm — ±30 mm

1 020 mm -MINIMUM

900 mm— ±100 mm NOV 22/17 ISSUED FOR REVIEW

DATE REMARKS NO.

DRAWING REVISIONS / ISSUES

Scott M. Kemp Architect

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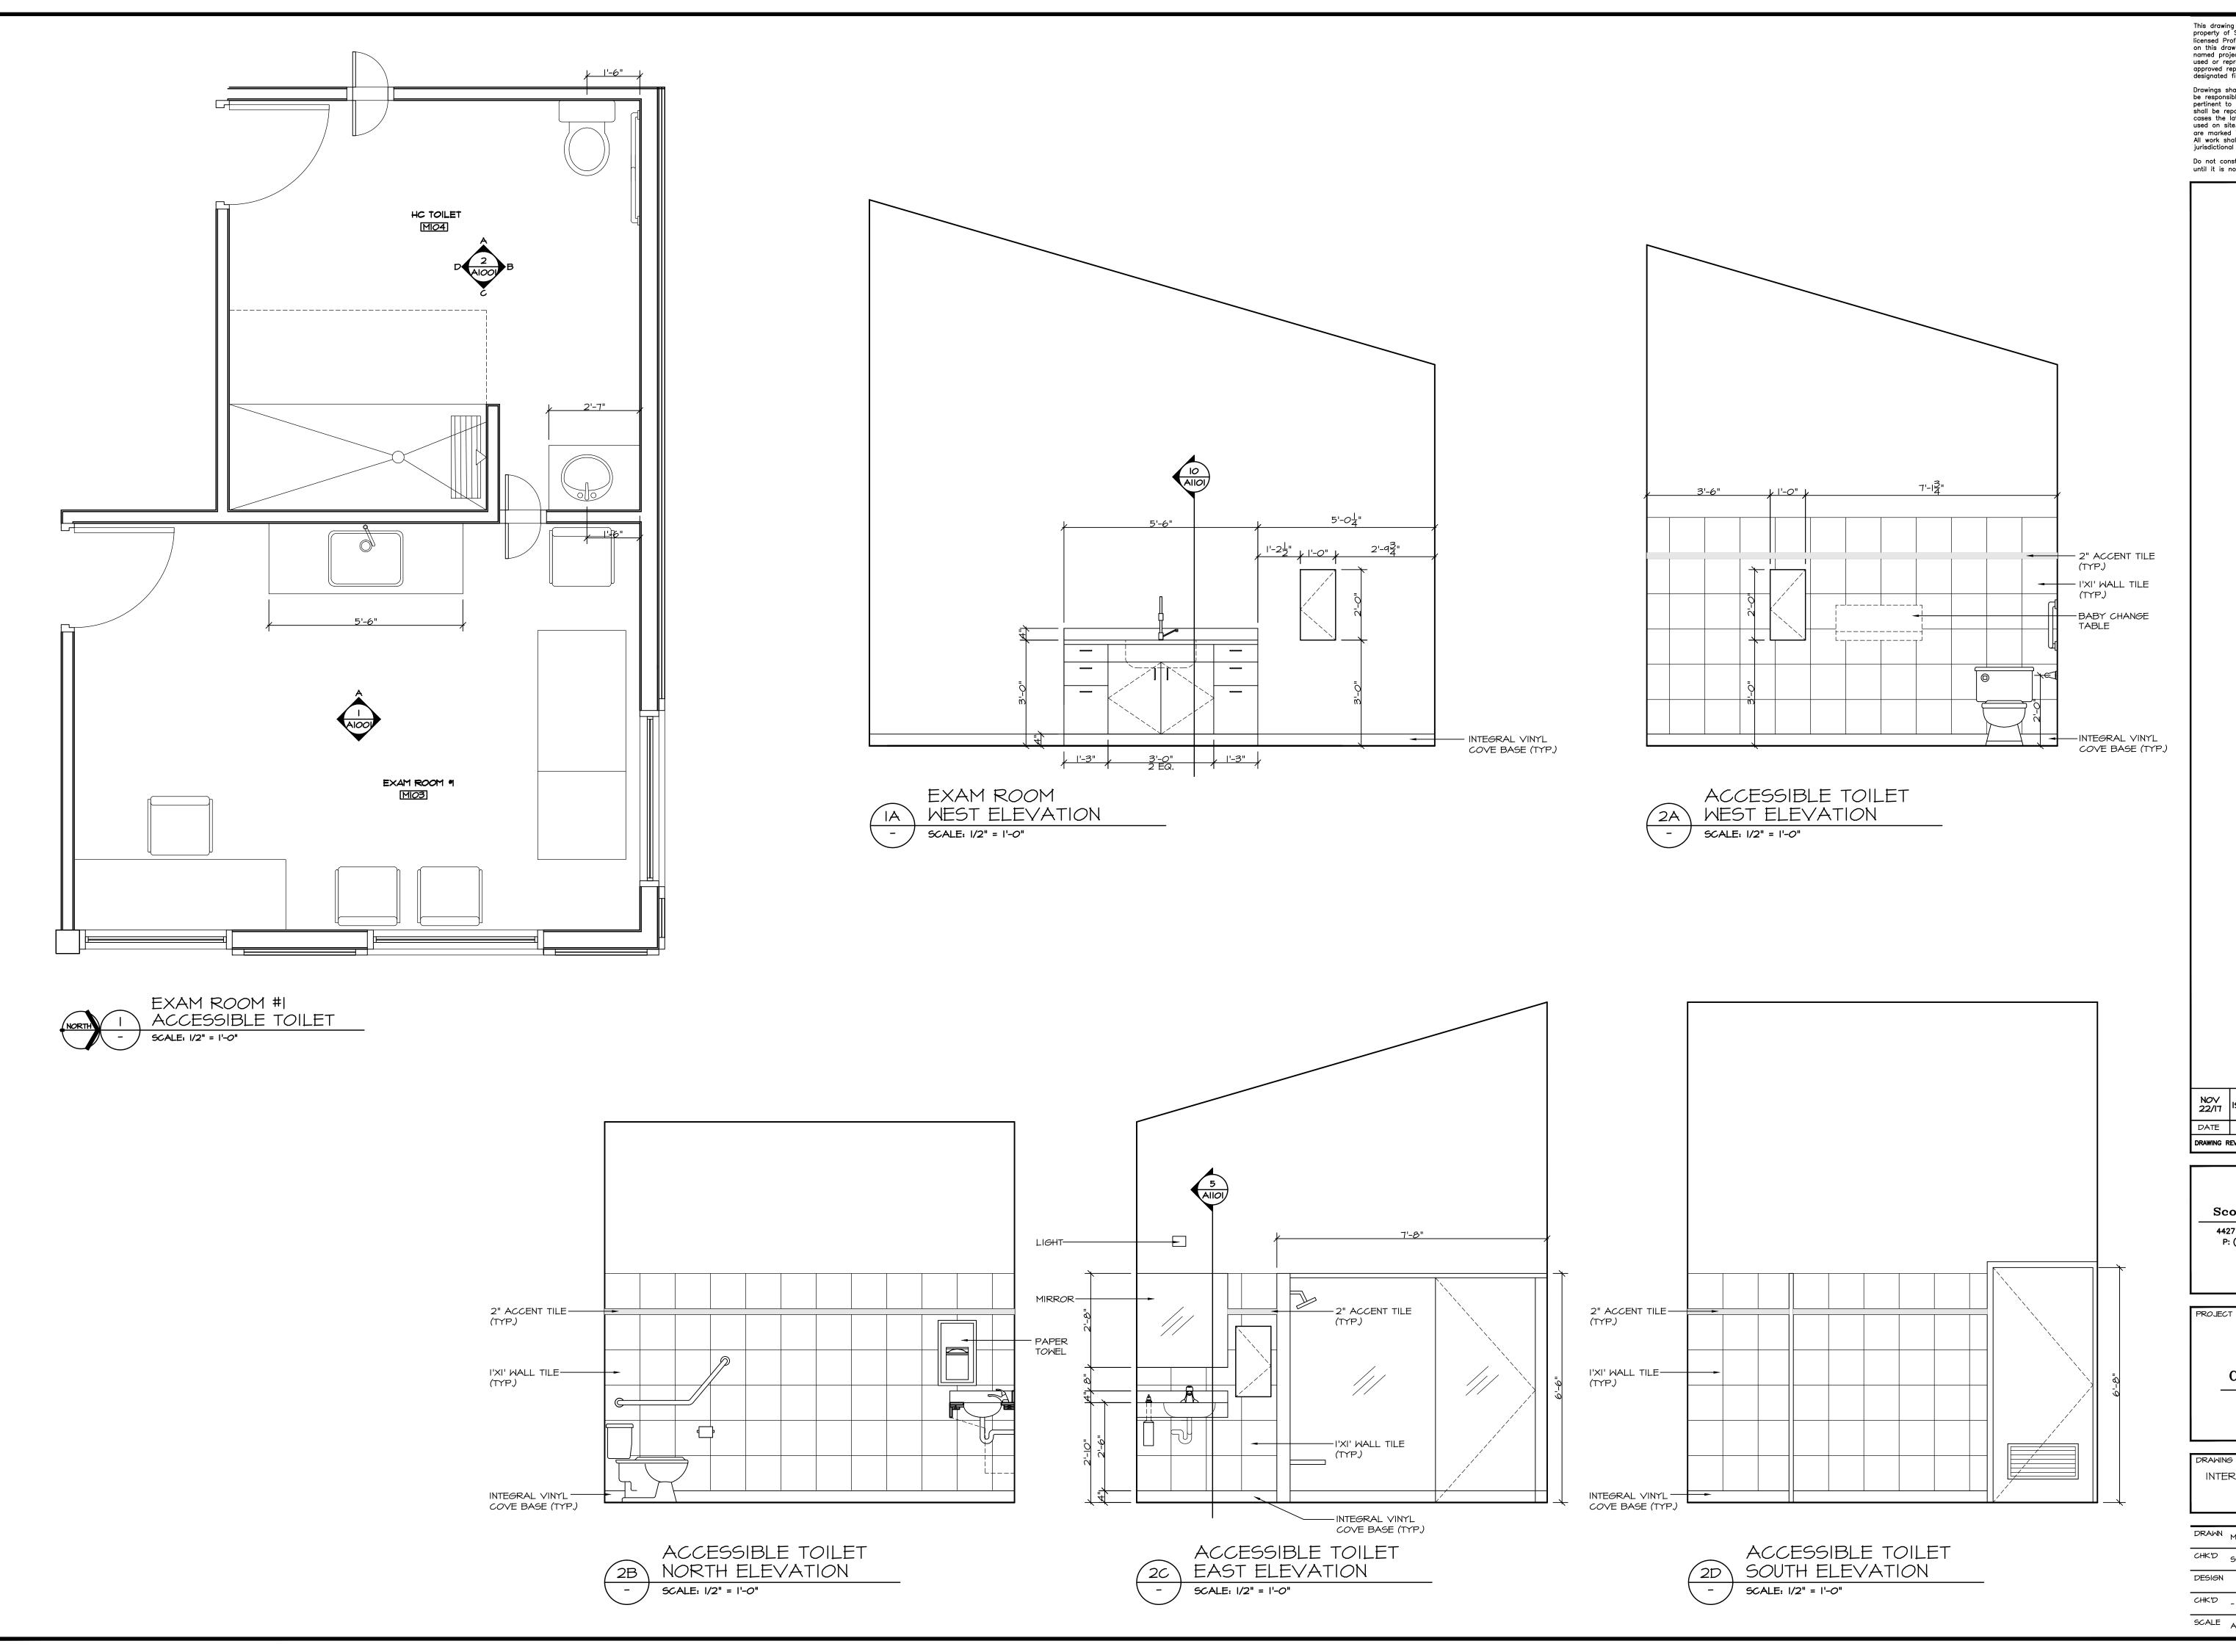
PROJECT

MALAHAT MULTIPURPOSE CULTURAL CENTRE

DRAWING TITLE

ACCESSIBLE REQUIREMENTS

DRAWN	ML	DATE	AUG/IT
CHK'D	5K	JOB No.	-
DESIGN		DRAWING	No.
CHK'D	-	Α	901
SCALE	AS SHOWN		



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NOV 22/17 ISSUED FOR REVIEW REMARKS DRAWING REVISIONS / ISSUES

Scott M. Kemp Architect


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MALAHAT MULTIPURPOSE


CULTURAL CENTRE Malahat, BC


DRAWING TITLE INTERIOR ELEVATIONS


DATE AUG/IT CHK'D SK JOB No. \_ CHK'D \_ A1001 SCALE AS SHOWN



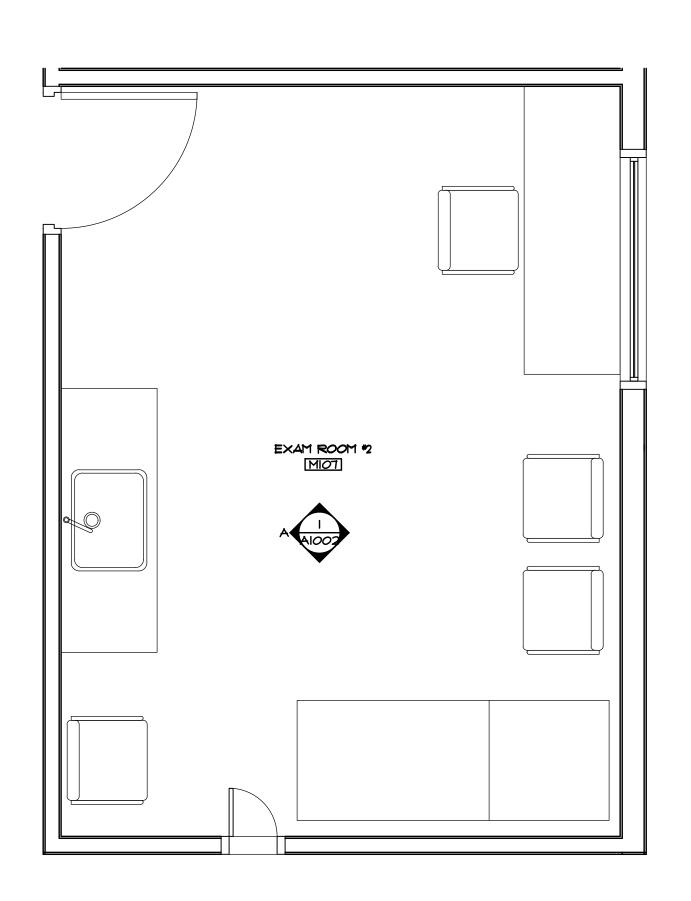

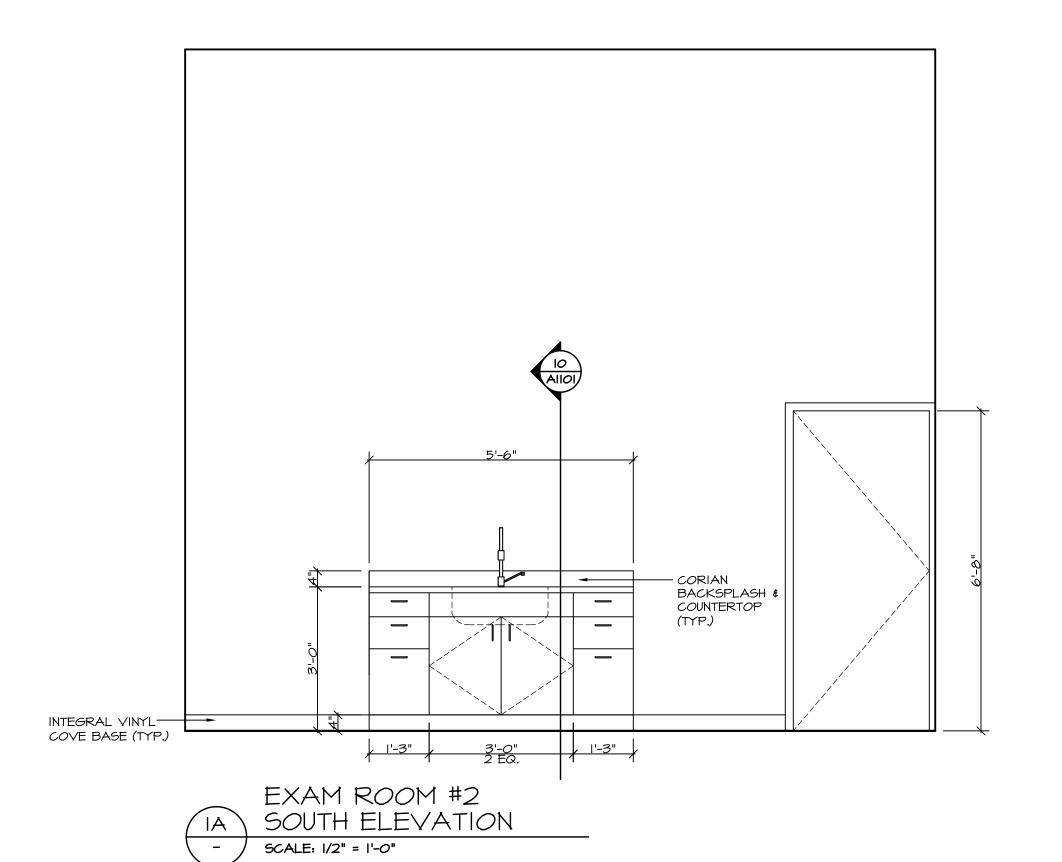

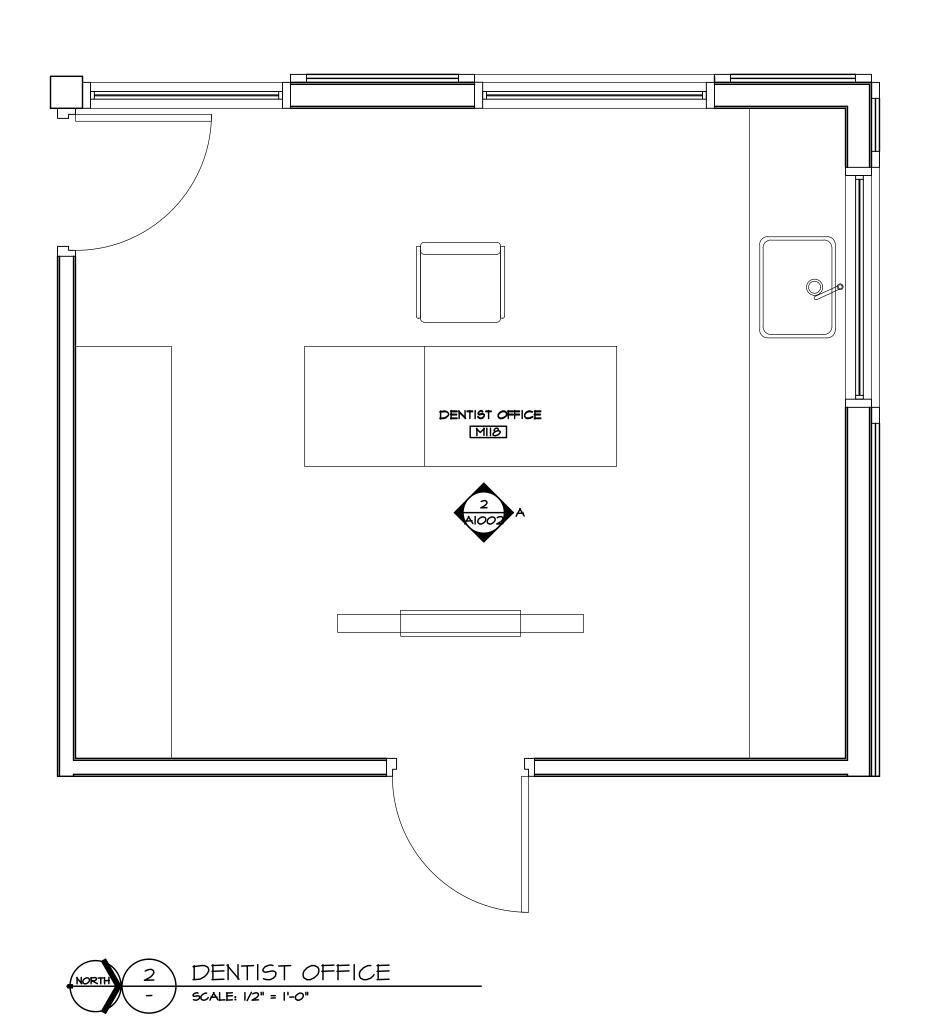

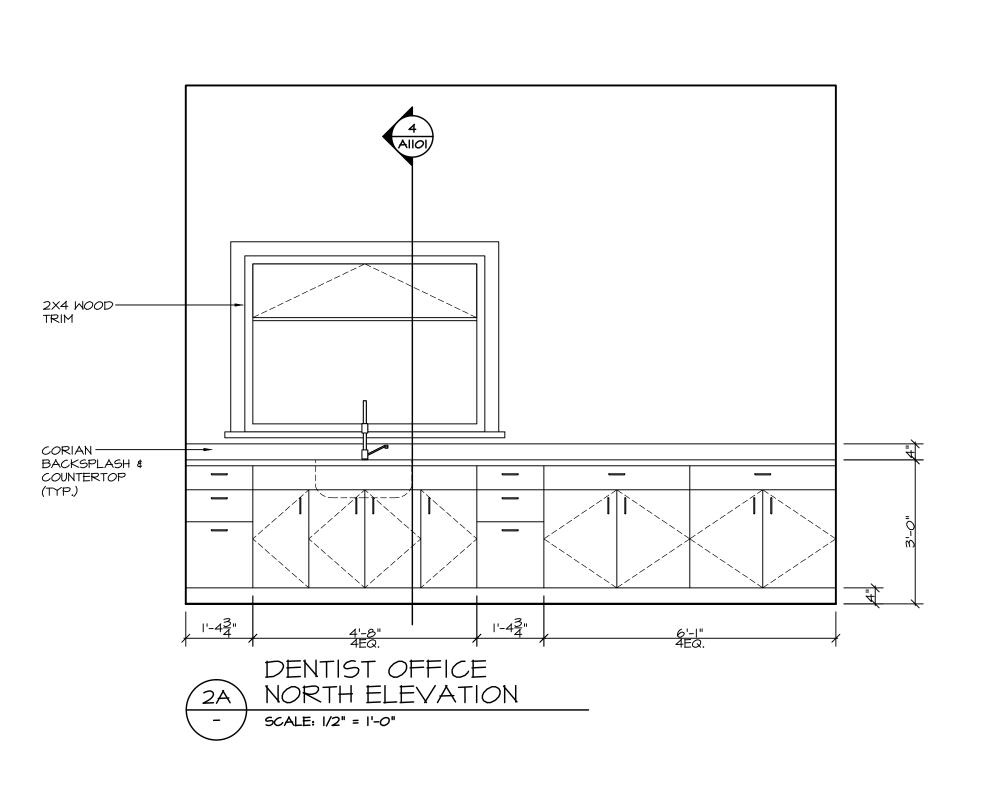

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NOV 22/17	ISSUED FOR REVIEW	<u>_</u>
DATE	REMARKS	NO.
DRAWING F	REVISIONS / ISSUES	

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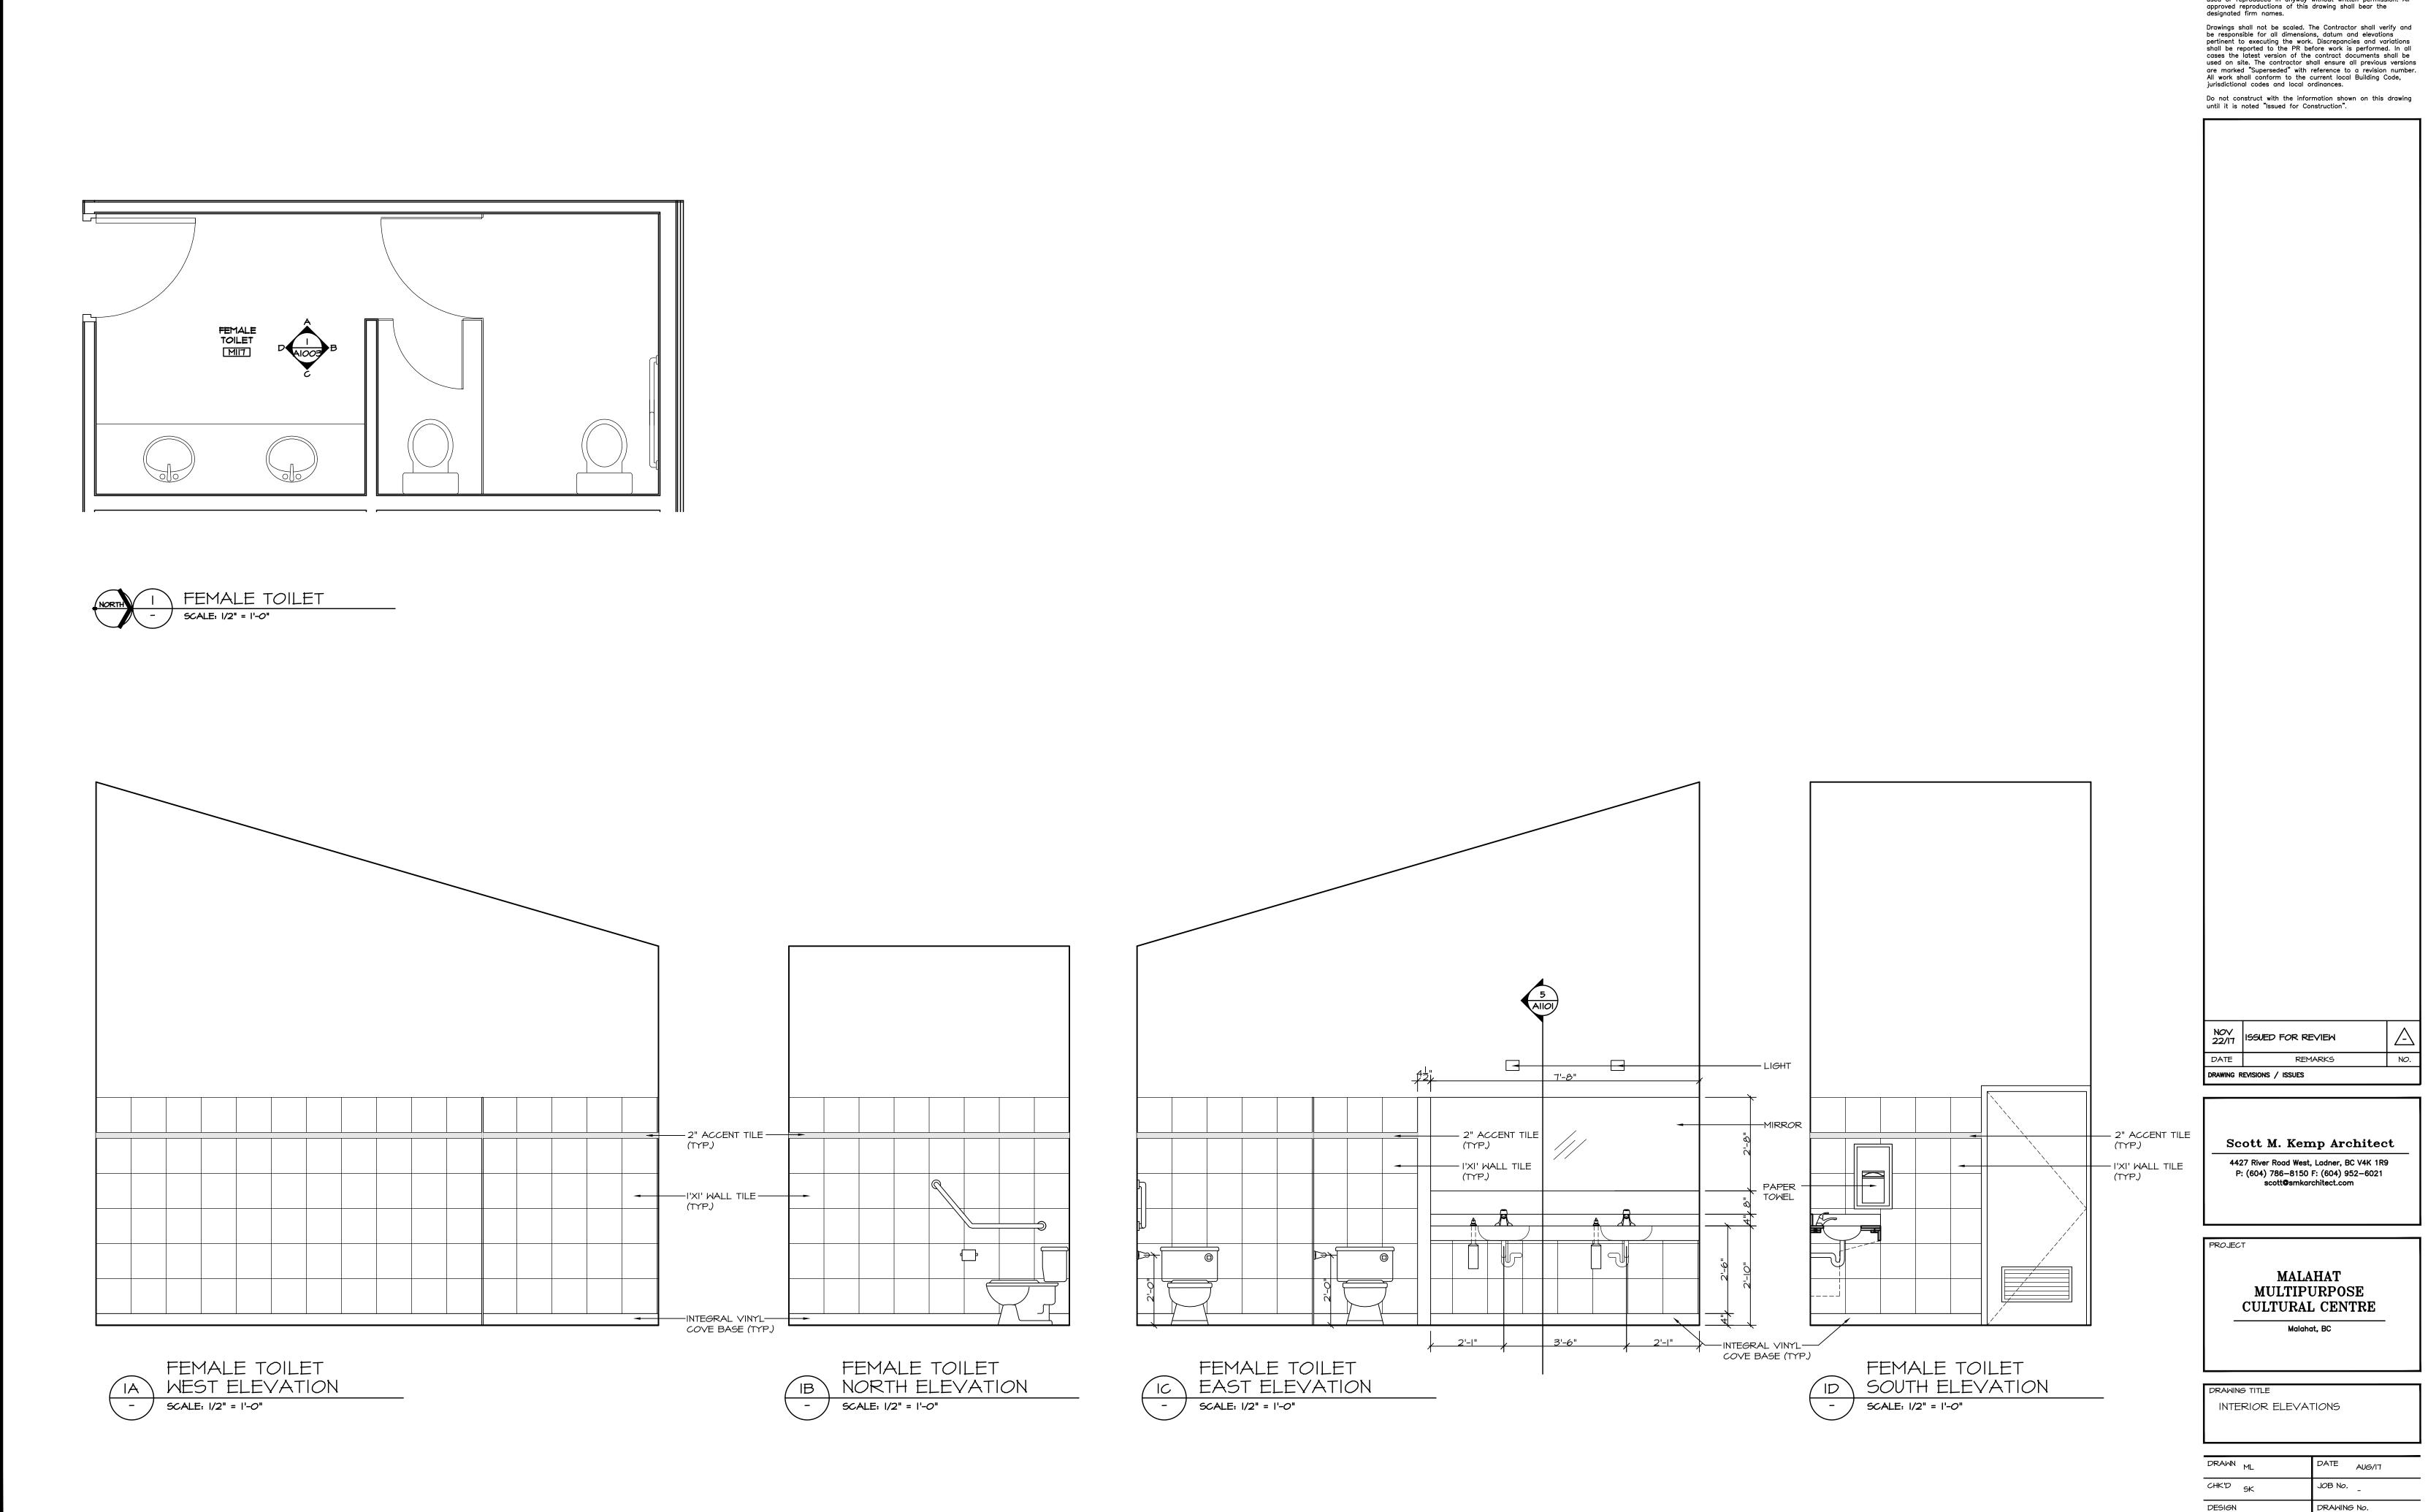
PROJECT

MALAHAT MULTIPURPOSE CULTURAL CENTRE


Malahat, BC

DRAWING TITLE
INTERIOR ELEVATIONS


DRAWN ML	DATE AUG/IT
CHK'D 5K	JOB No
DESIGN	DRAWING No.
CHK'D _	A1002
SCALE AS SHOWN	



DESIGN CHK'D \_ A1003 SCALE AS SHOWN

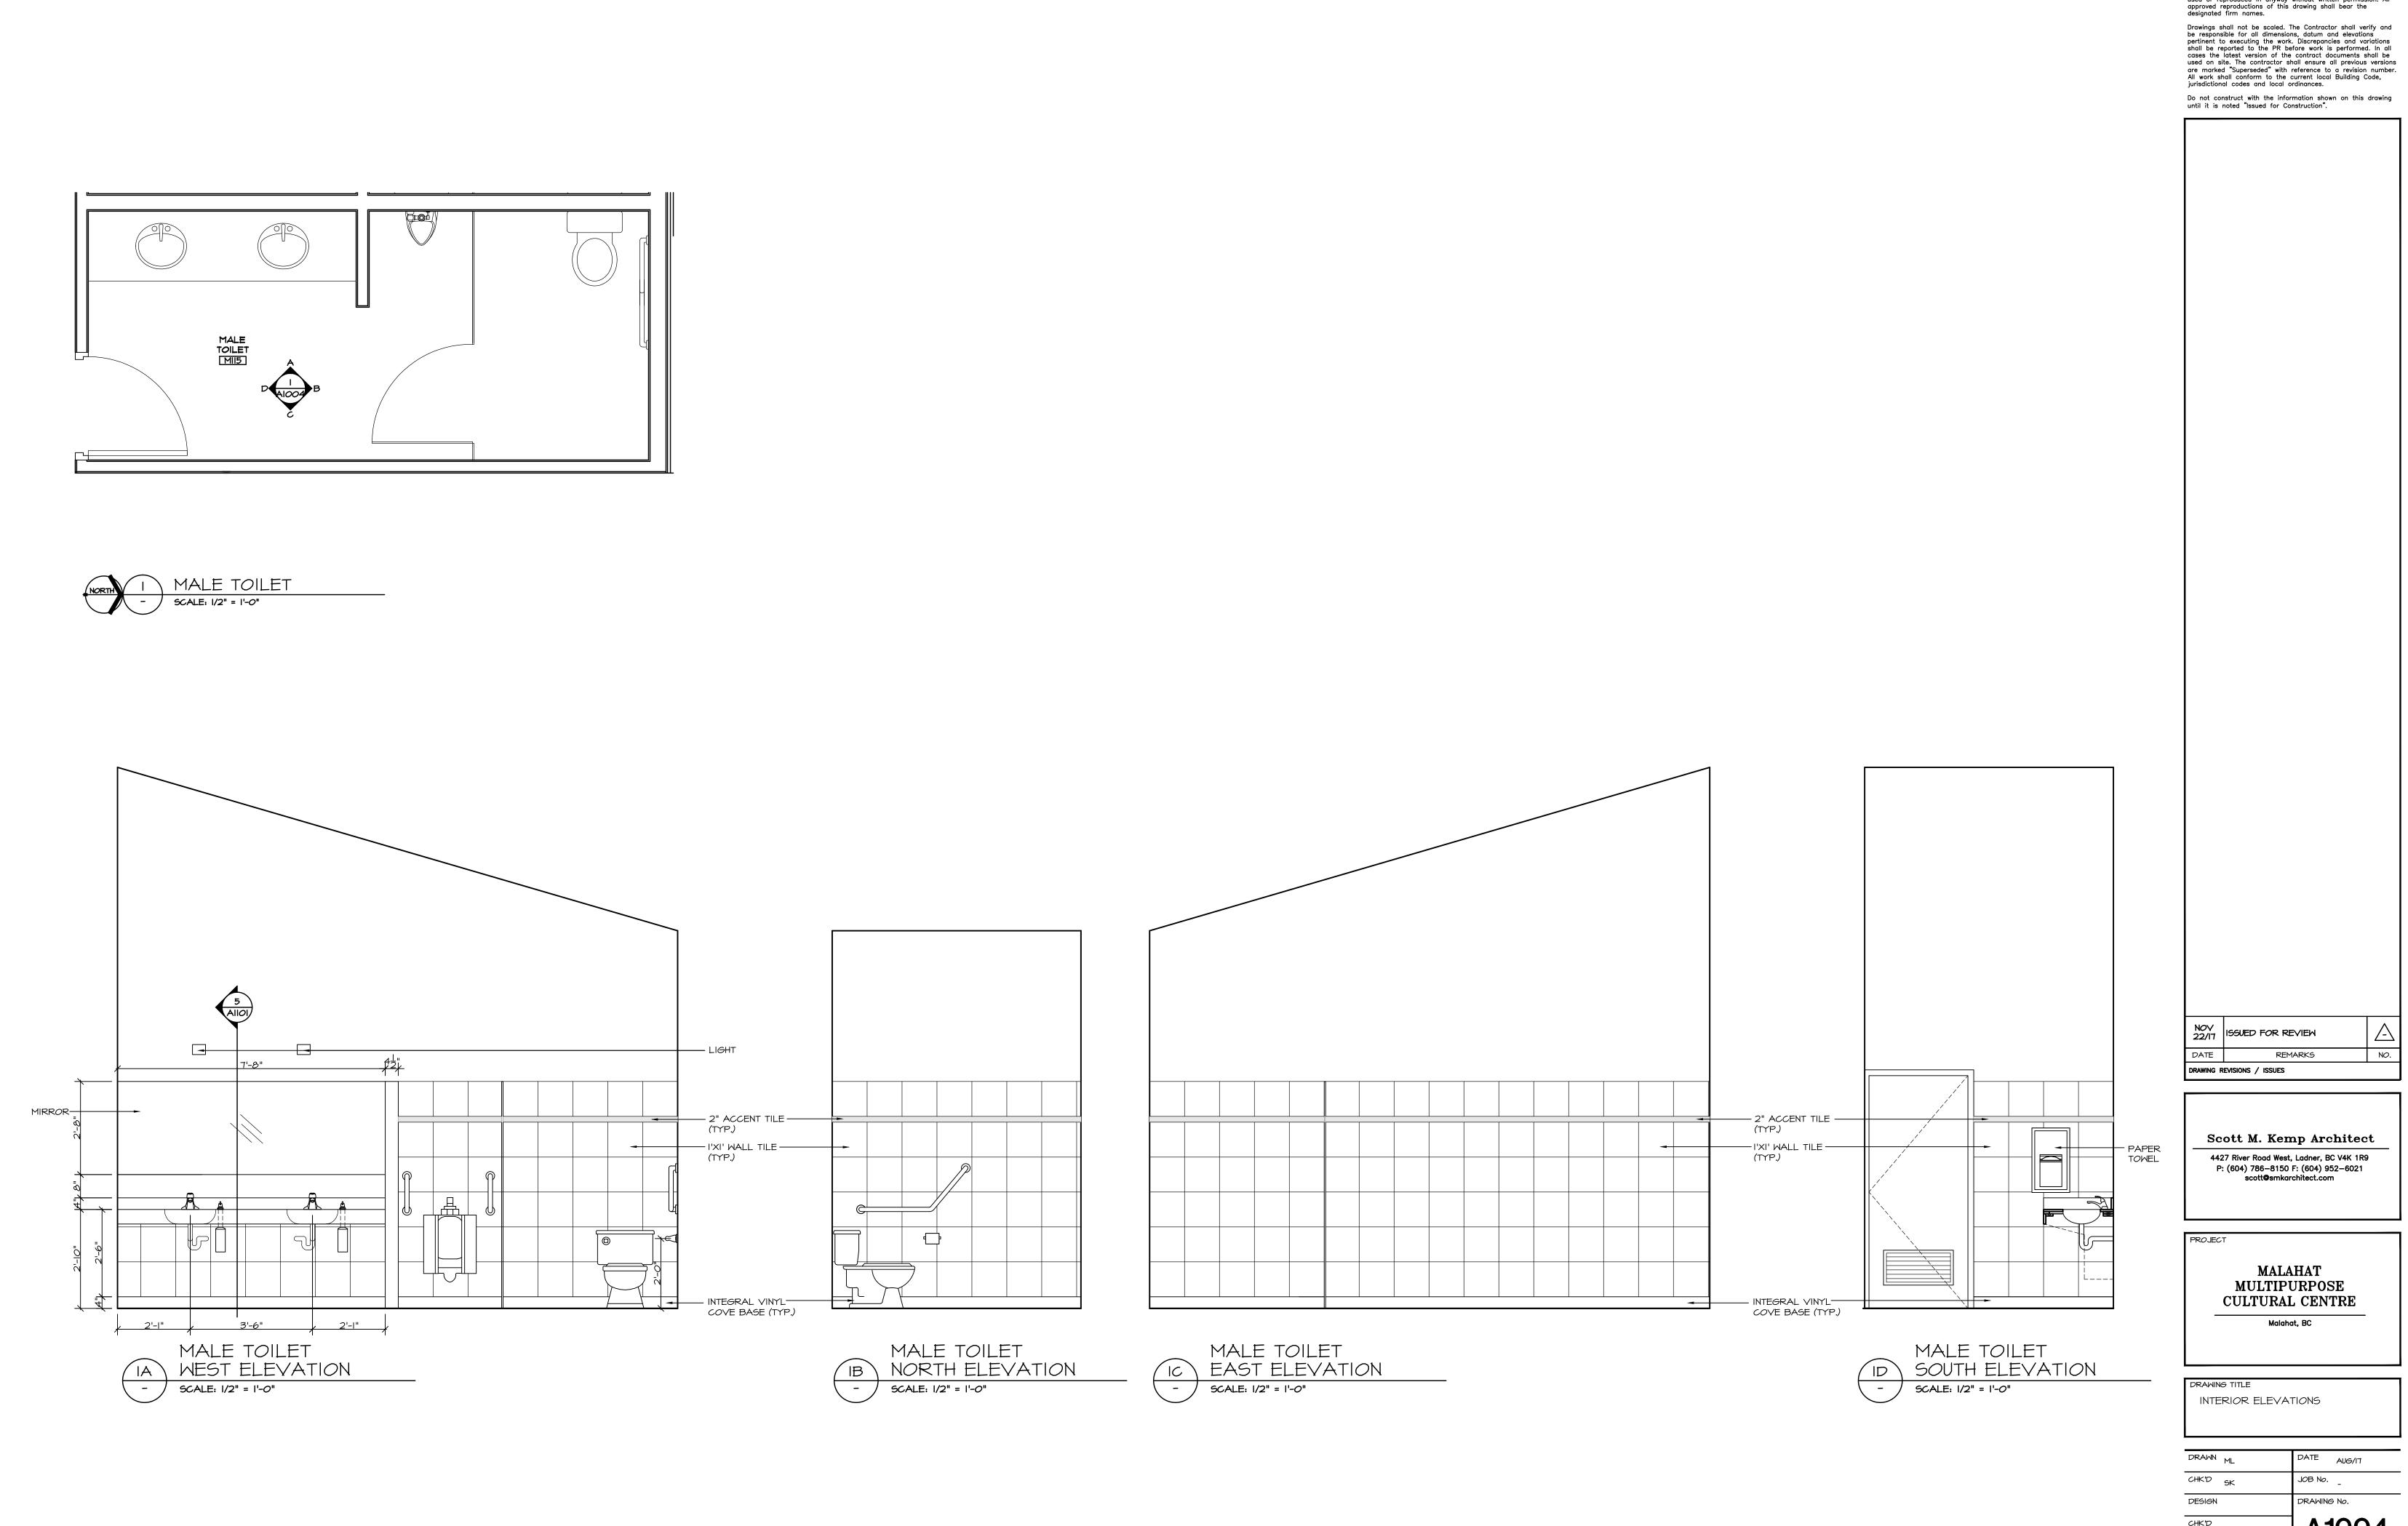

CHK'D \_ A1004 SCALE AS SHOWN

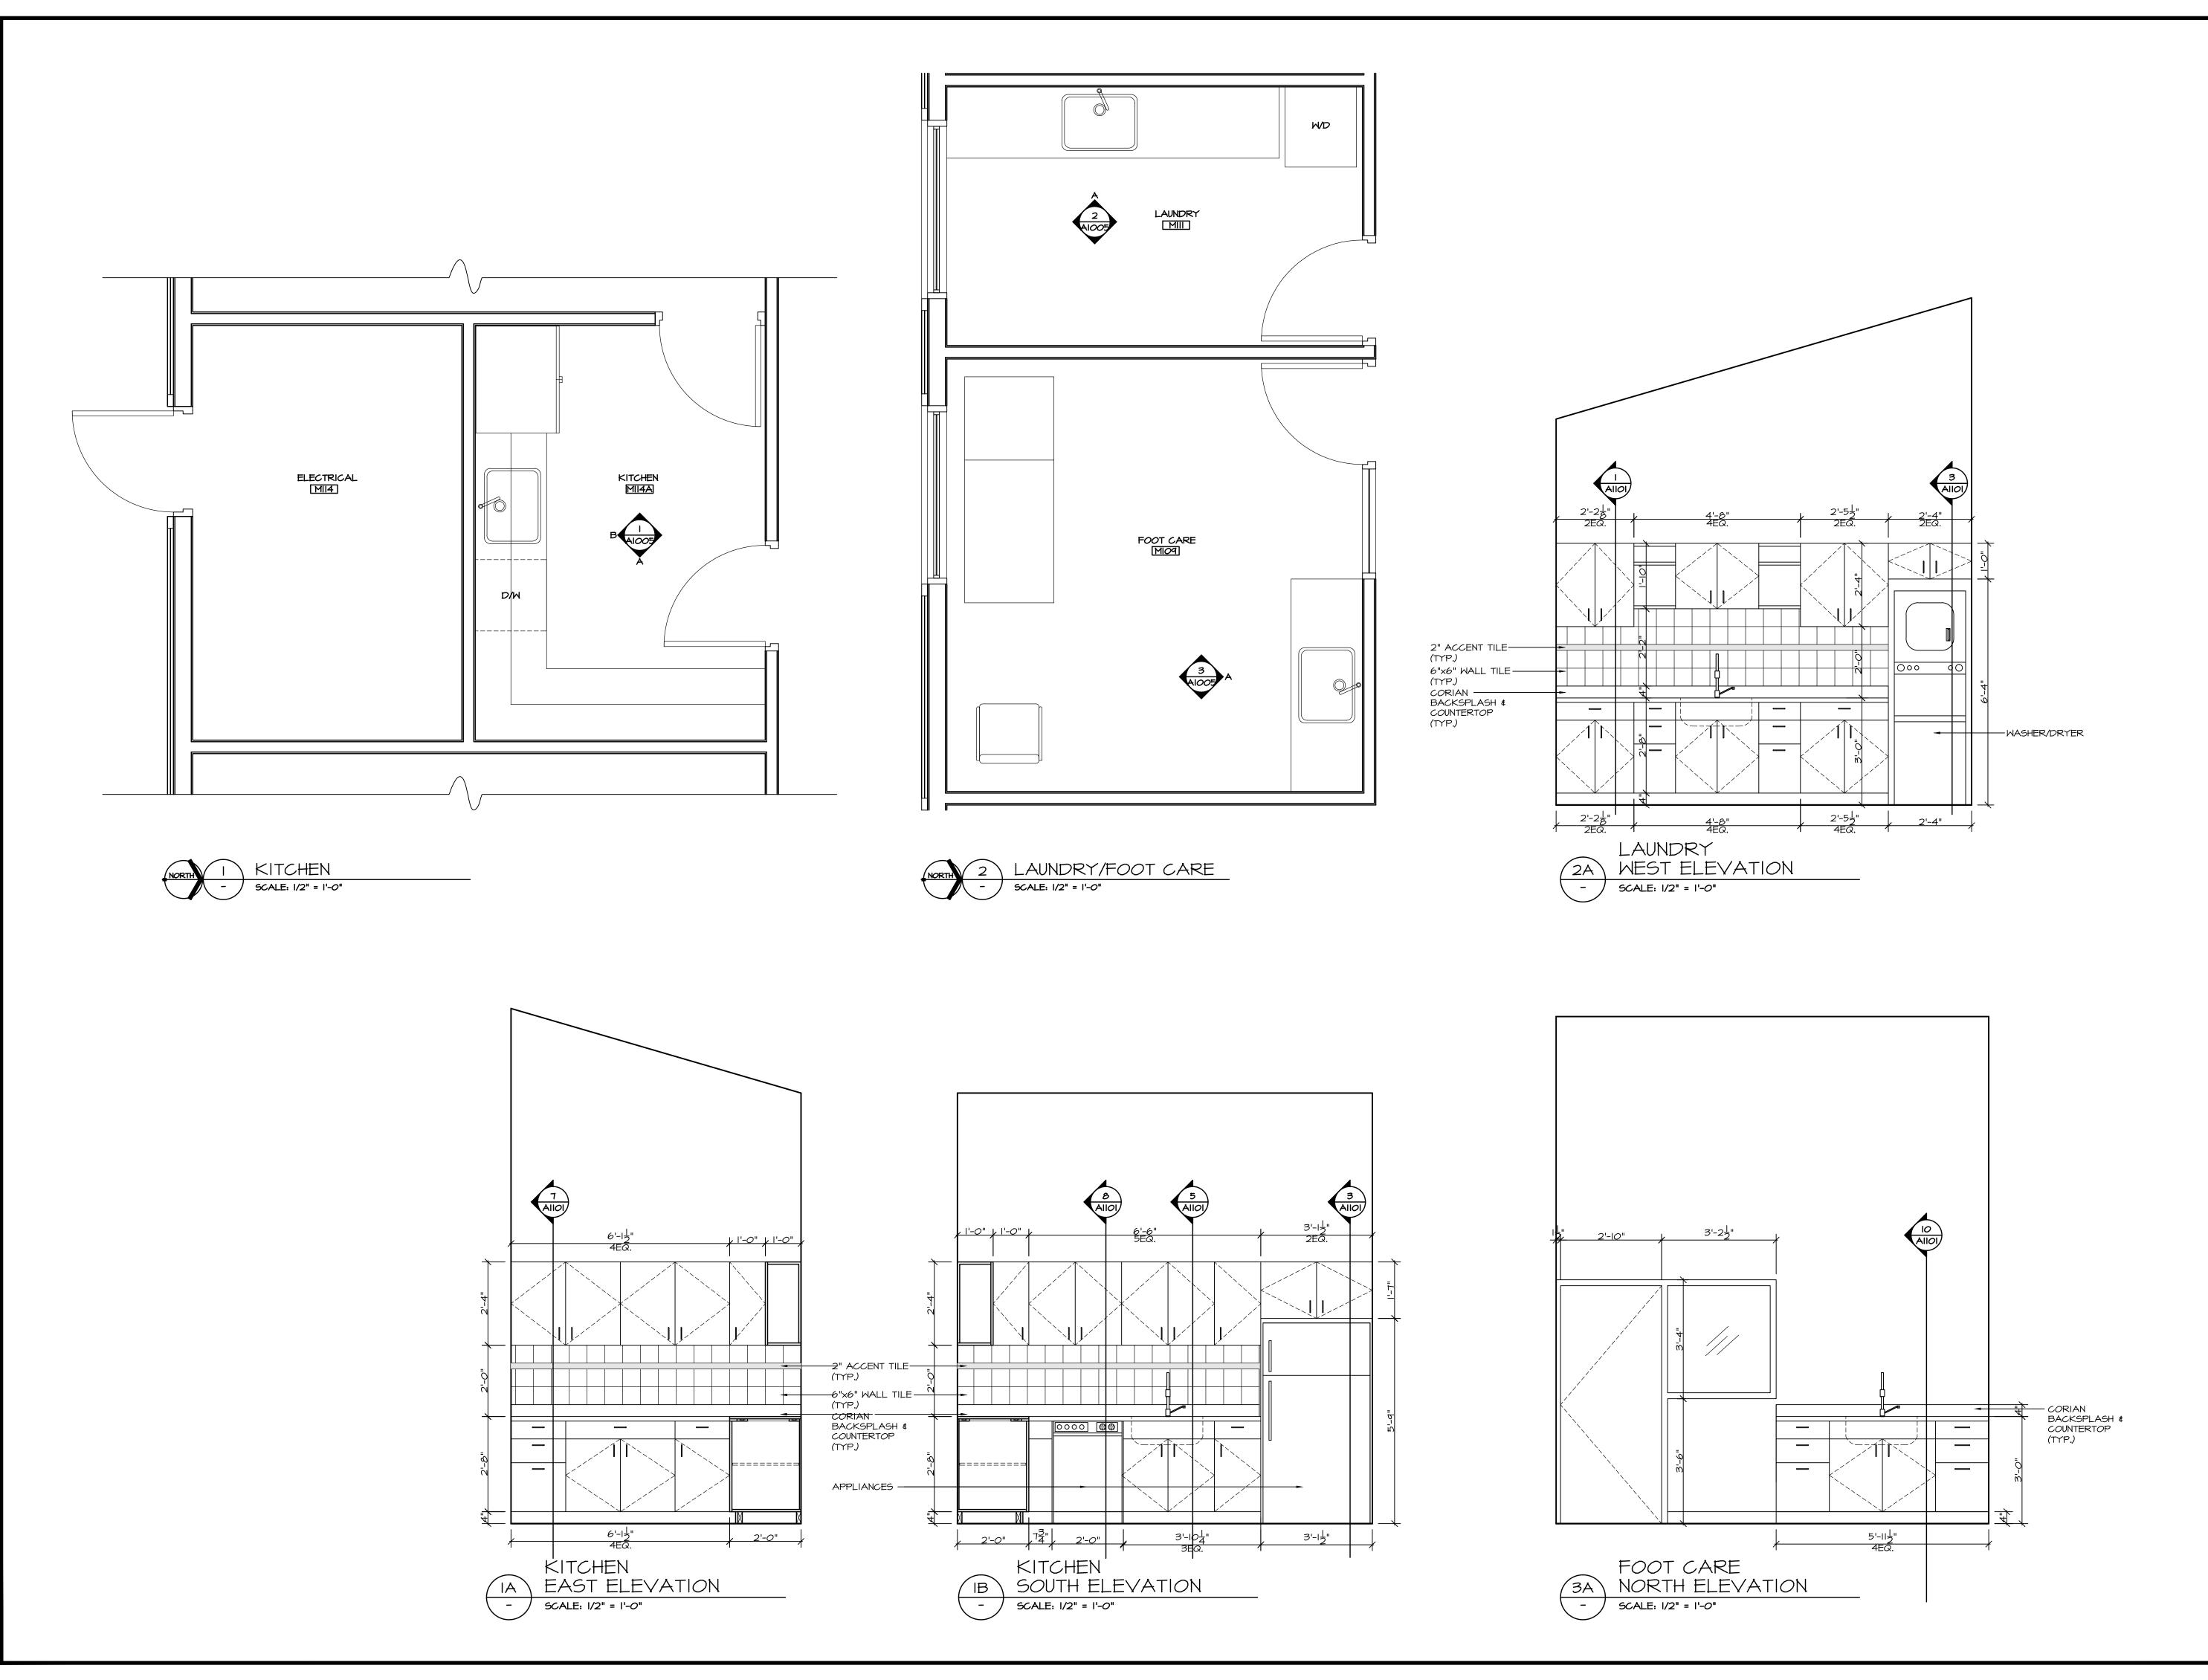

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DATE	REMARKS	NO.

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MALAHAT
MULTIPURPOSE
CULTURAL CENTRE

Malahat, BC

DRAWING TITLE
INTERIOR ELEVATIONS

DRAWN ML

CHK'D SK

DESIGN

DRAWING No.

CHK'D 
SCALE AS SHOWN

DATE AUG/IT

AUG/IT

AUG/IT

AUG/IT


AUG/IT

AUG/IT


AUG/IT

ANGLE


AUG/IT

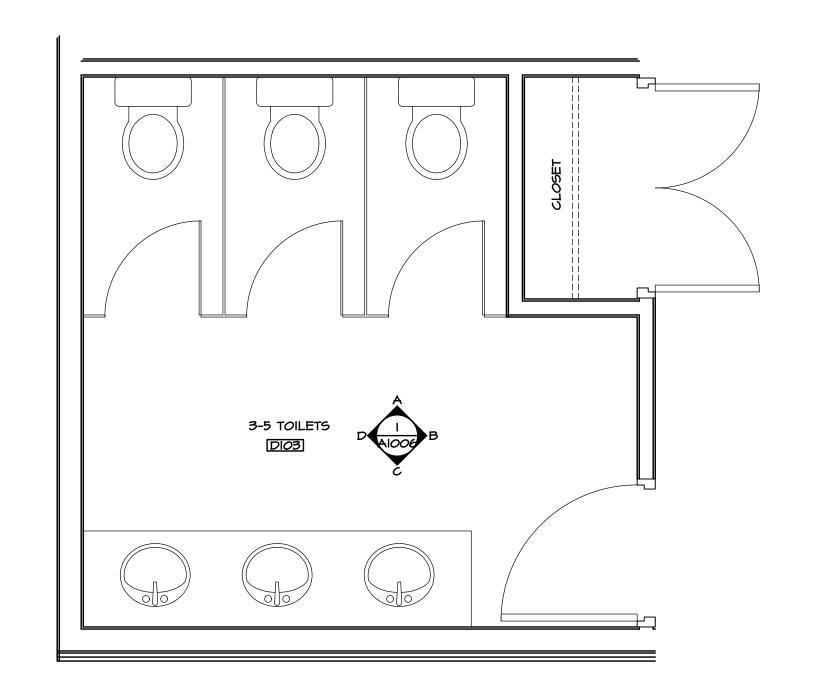



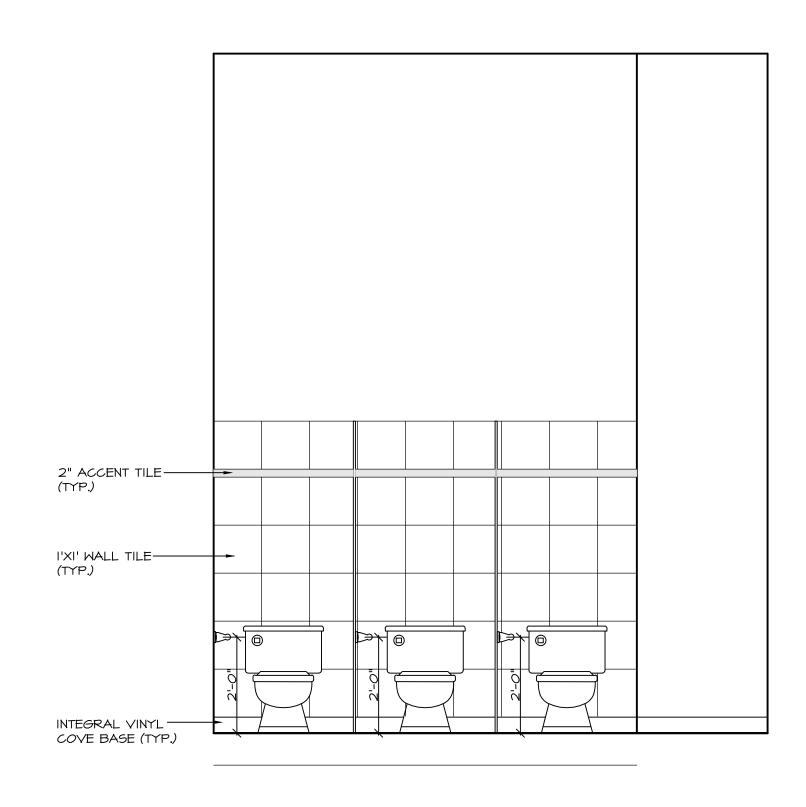




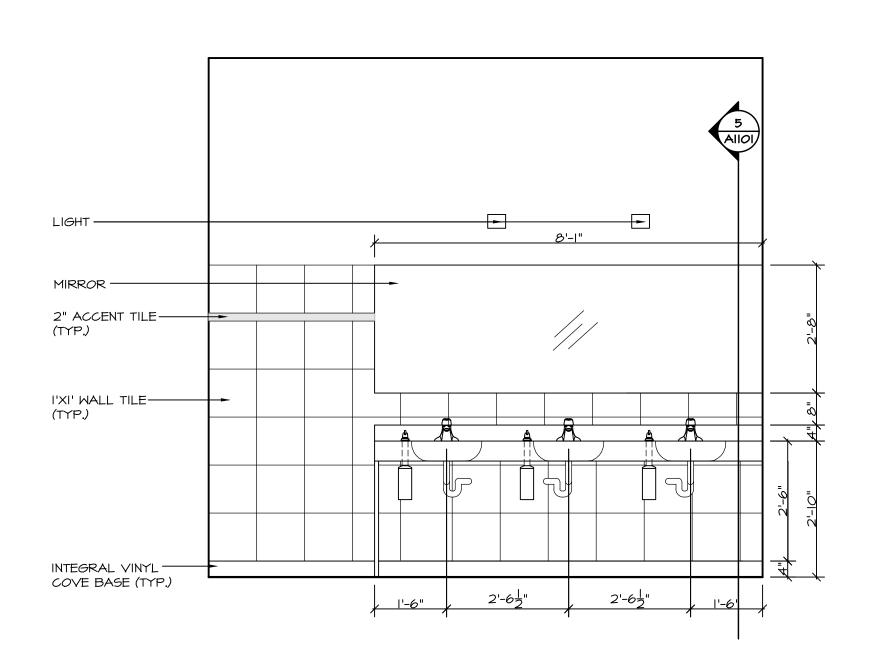


3-5 TOILETS

IC EAST ELEVATION

- SCALE: 1/2" = 1'-0"

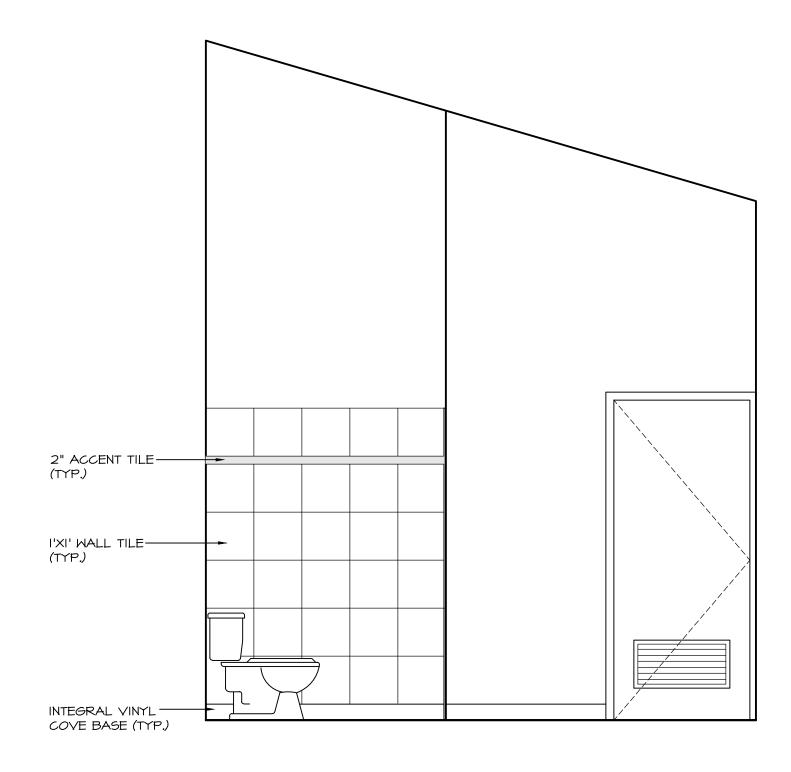



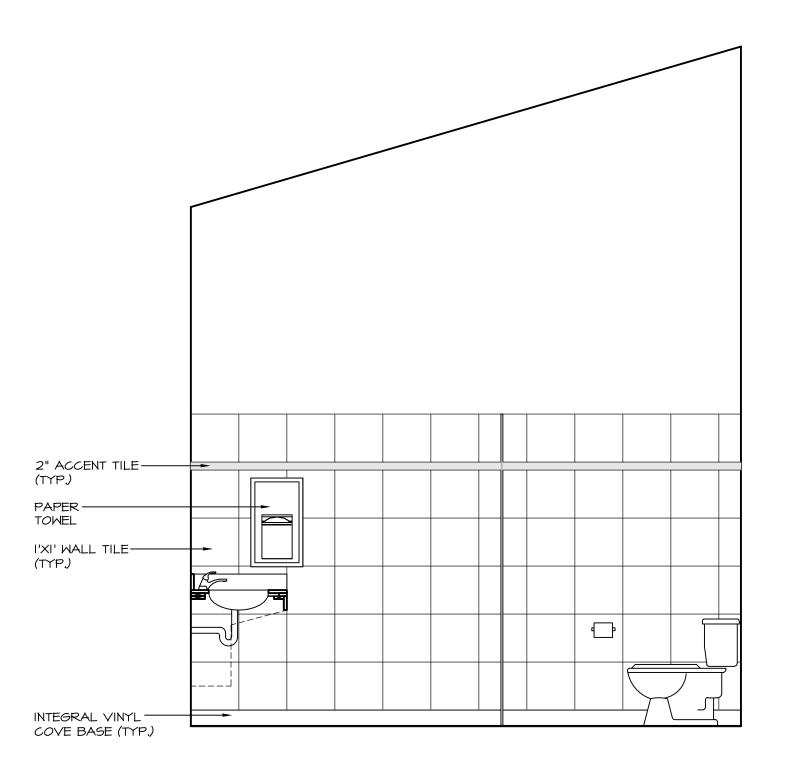

3-5 TOILETS
SOUTH ELEVATION
- SCALE: 1/2" = 1'-0"

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NOY 22/17	ISSUED FOR REVIEW	<u> </u>	_/
DATE	REMARKS	No	0.
DRAWING I	REVISIONS / ISSUES		

P: (604) 786-8150 F: (604) 952-6021

MALAHAT MULTIPURPOSE

CULTURAL CENTRE


Malahat, BC


PROJECT


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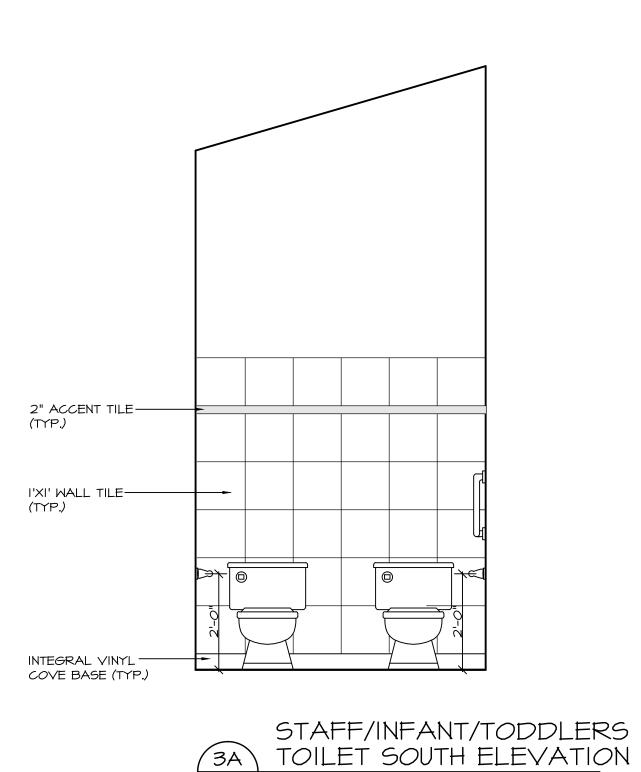
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INTERIOR ELEVATIONS






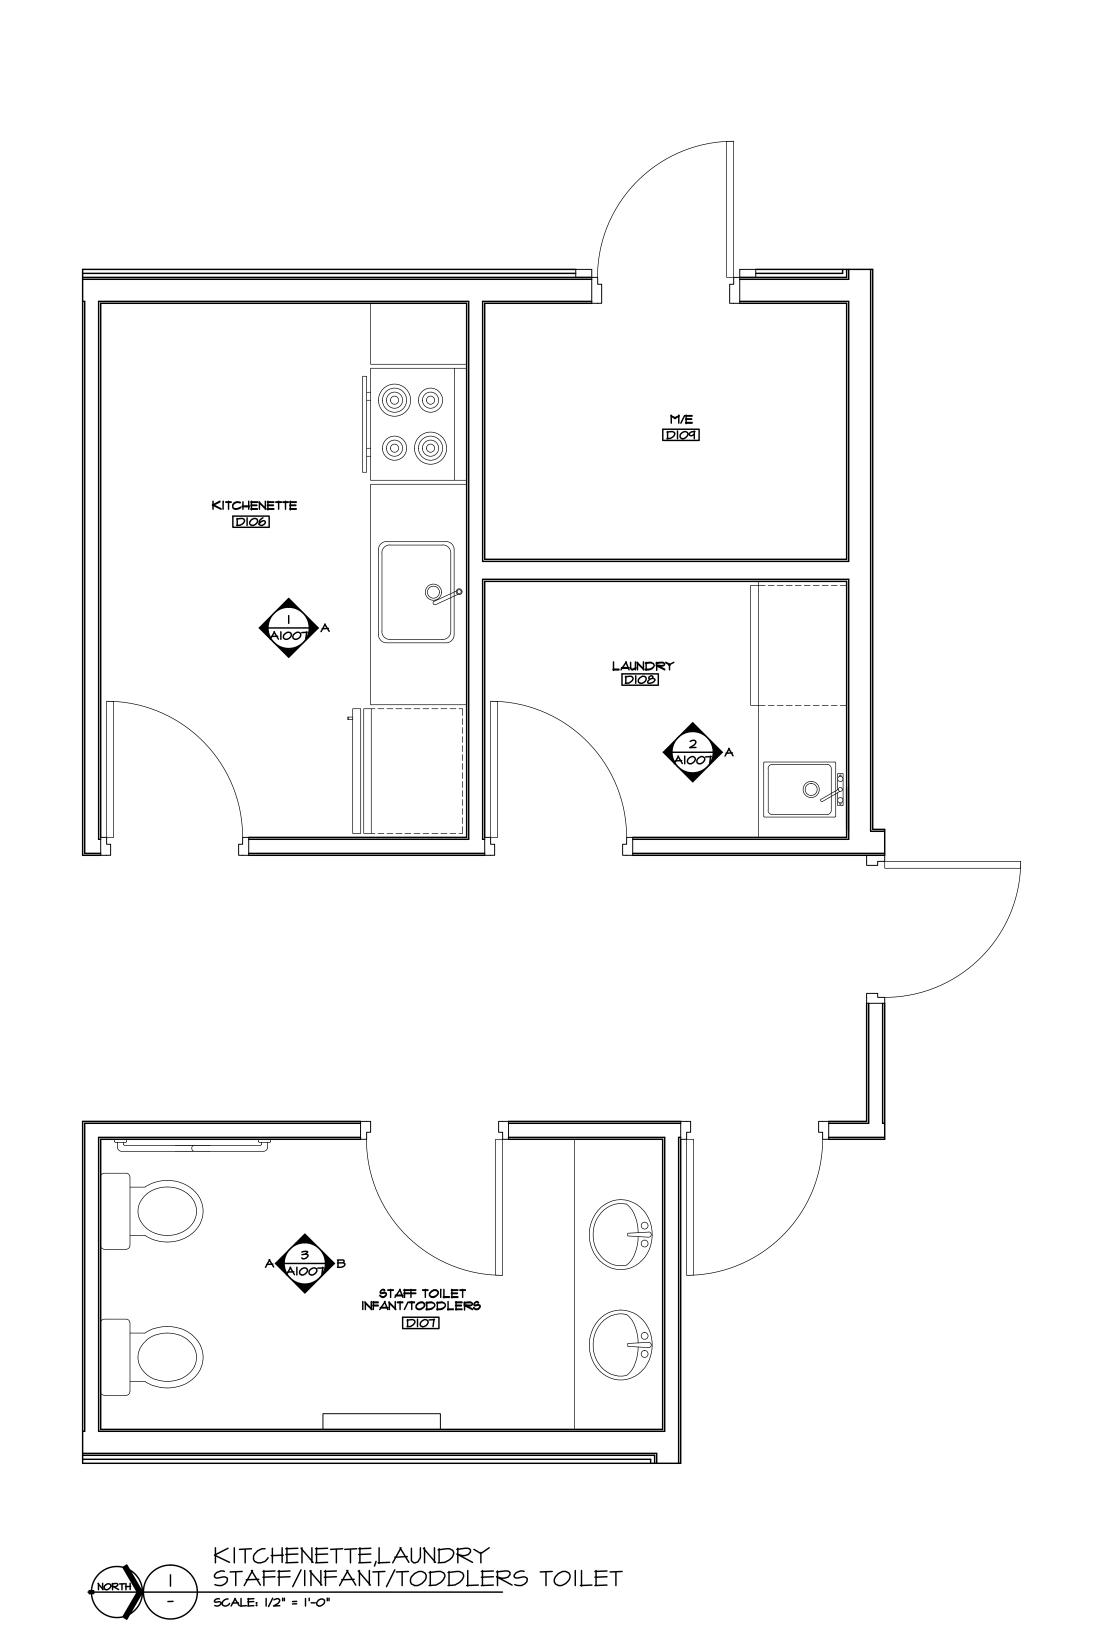

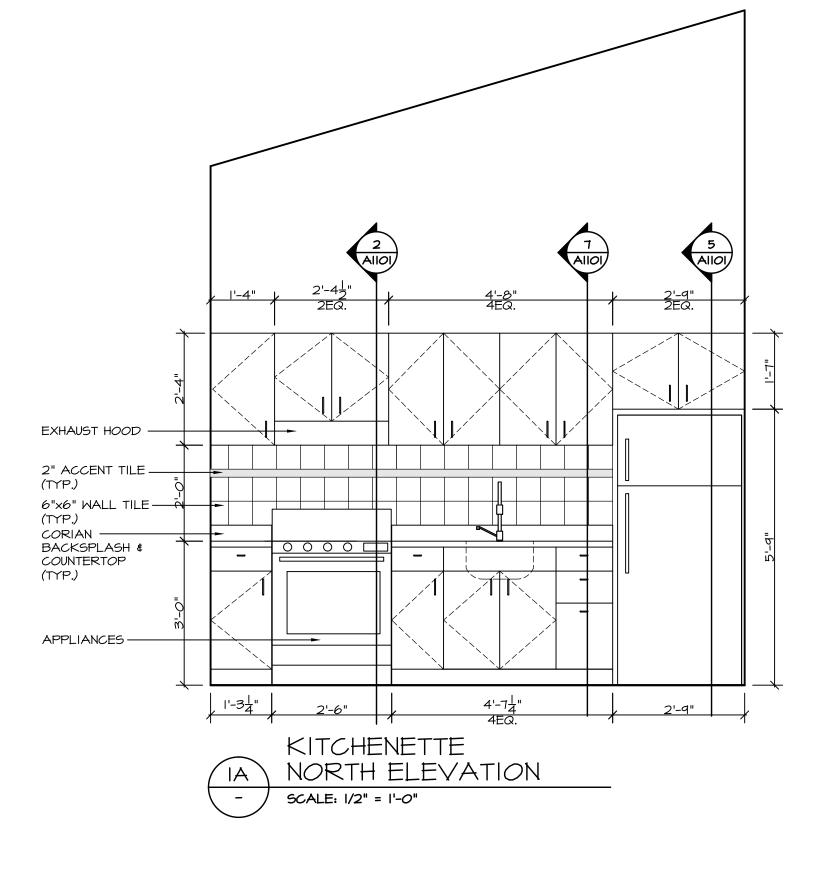

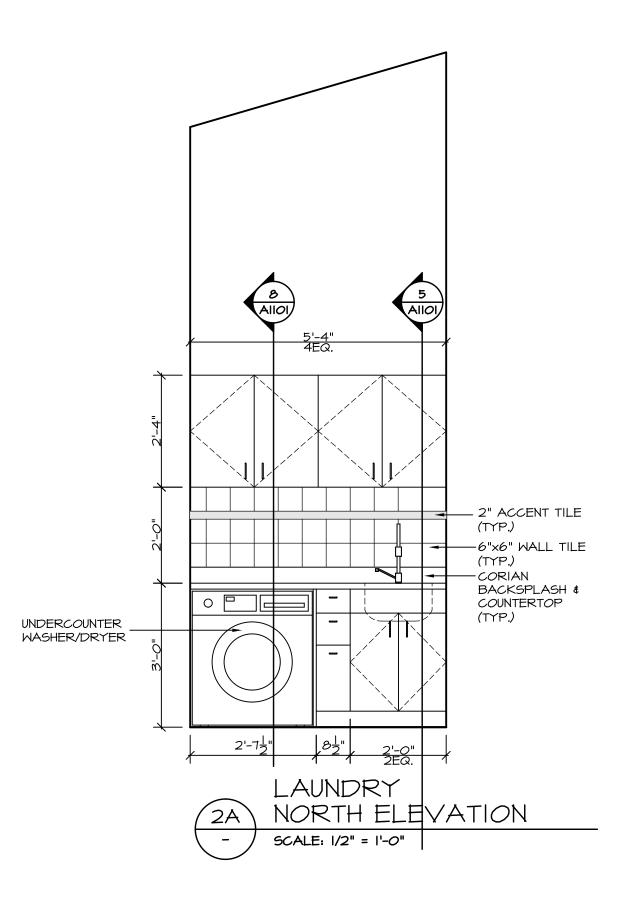SCALE: 1/2" = 1'-0"

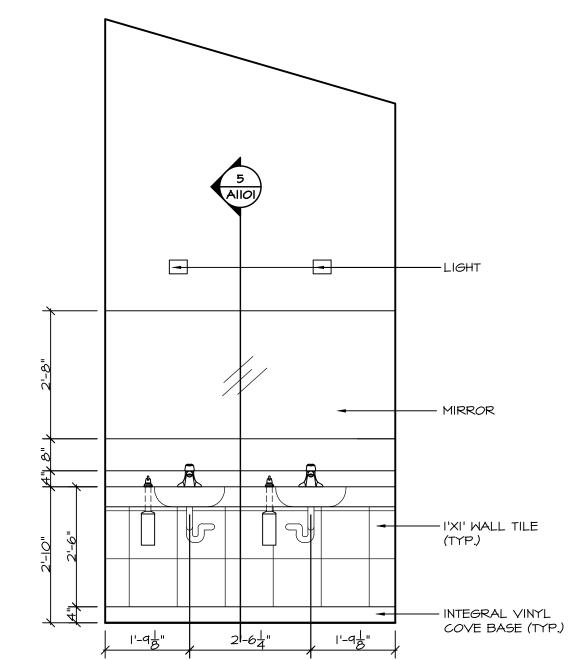

STAFF/INFANT/TODDLERS

TOILET NORTH ELEVATION

- SCALE: 1/2" = 1'-0"

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NOY 22/17	ISSUED FOR REVIEW	<u>_</u>	
DATE	REMARKS	NO.	
DRAWING REVISIONS / ISSUES			

Scott M. Kemp Architect


4427 River Road West, Ladner, BC V4K 1R9
P: (604) 786-8150 F: (604) 952-6021
scott@smkarchitect.com

MALAHAT
MULTIPURPOSE
CULTURAL CENTRE

Malahat, BC

DRAWING TITLE
INTERIOR ELEVATIONS

DRAWN	ML	DATE	AUG/IT
CHK'D	5K	JOB No.	-
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CHK'D	-	<b>A</b> 1	1007
SCALE	AS SHOWN		

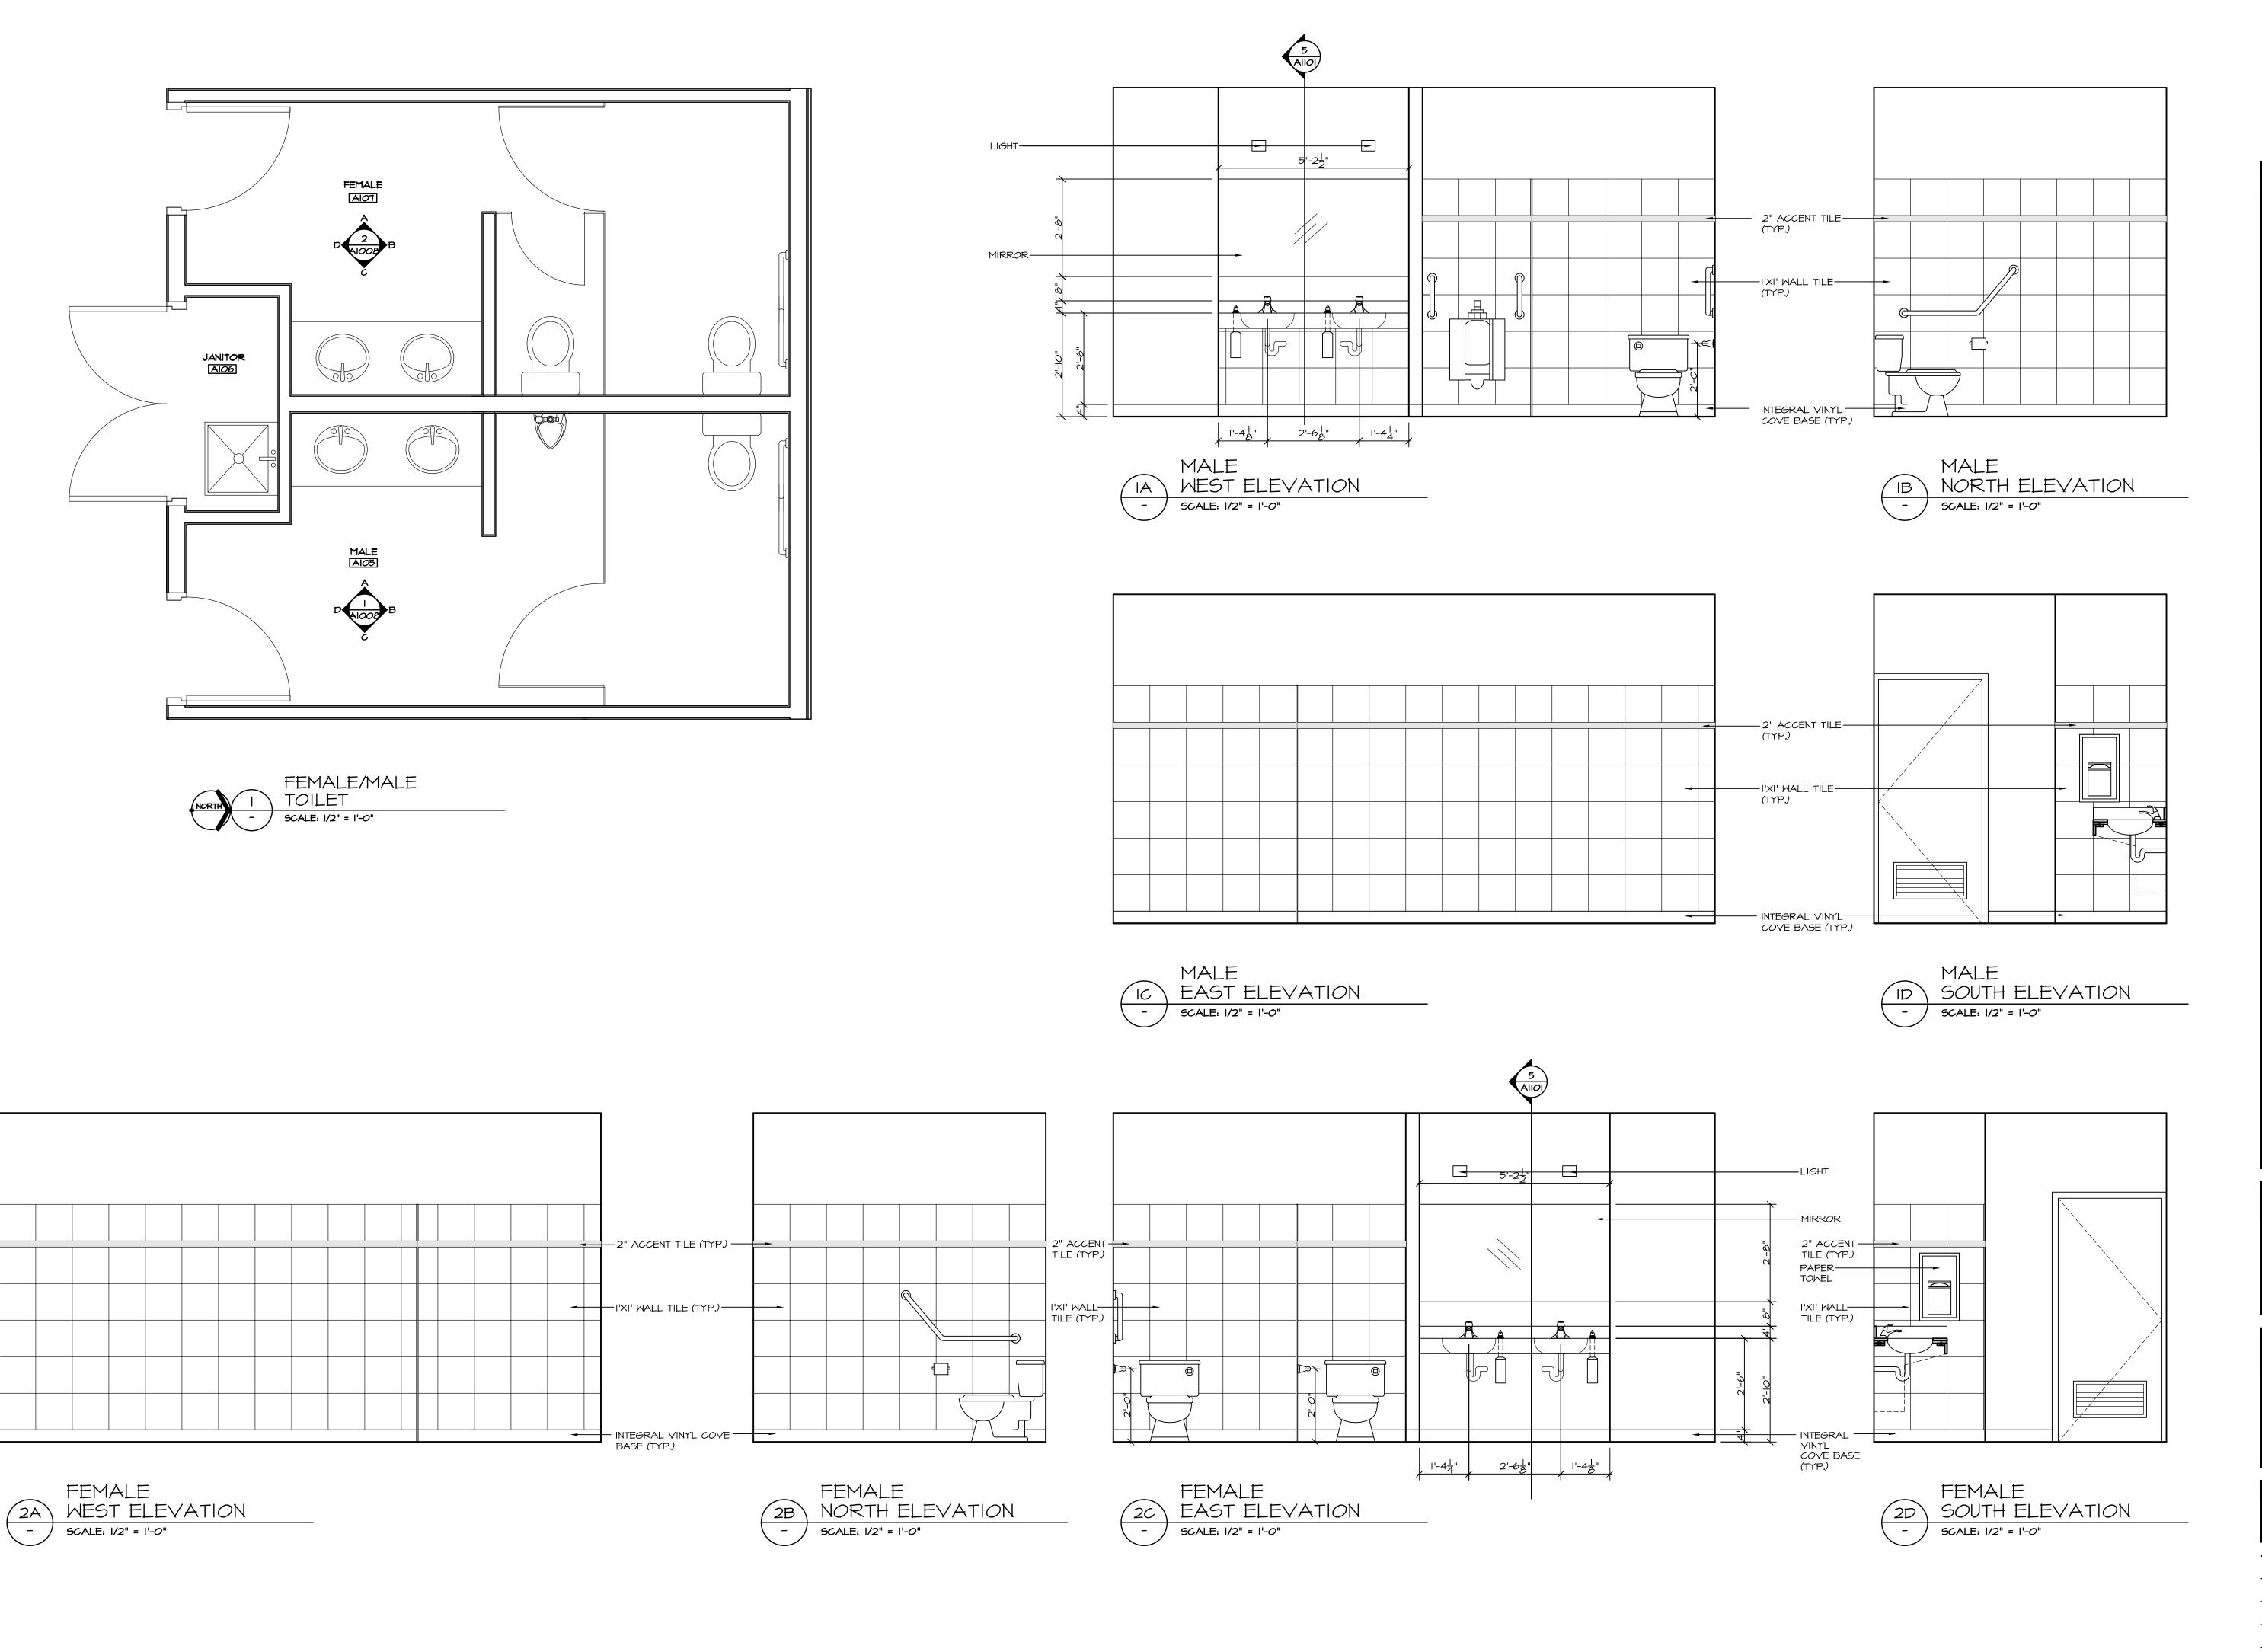

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Scott M. Kemp Architect

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PROJECT

MALAHAT MULTIPURPOSE CULTURAL CENTRE

Malahat, BC

DRAWING TITLE
INTERIOR ELEVATIONS


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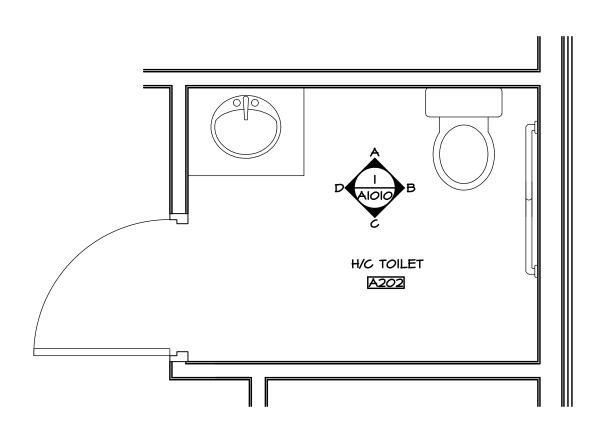
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DESIGN DRAWING No.

CHK'D \_

SCALE AS SHOWN






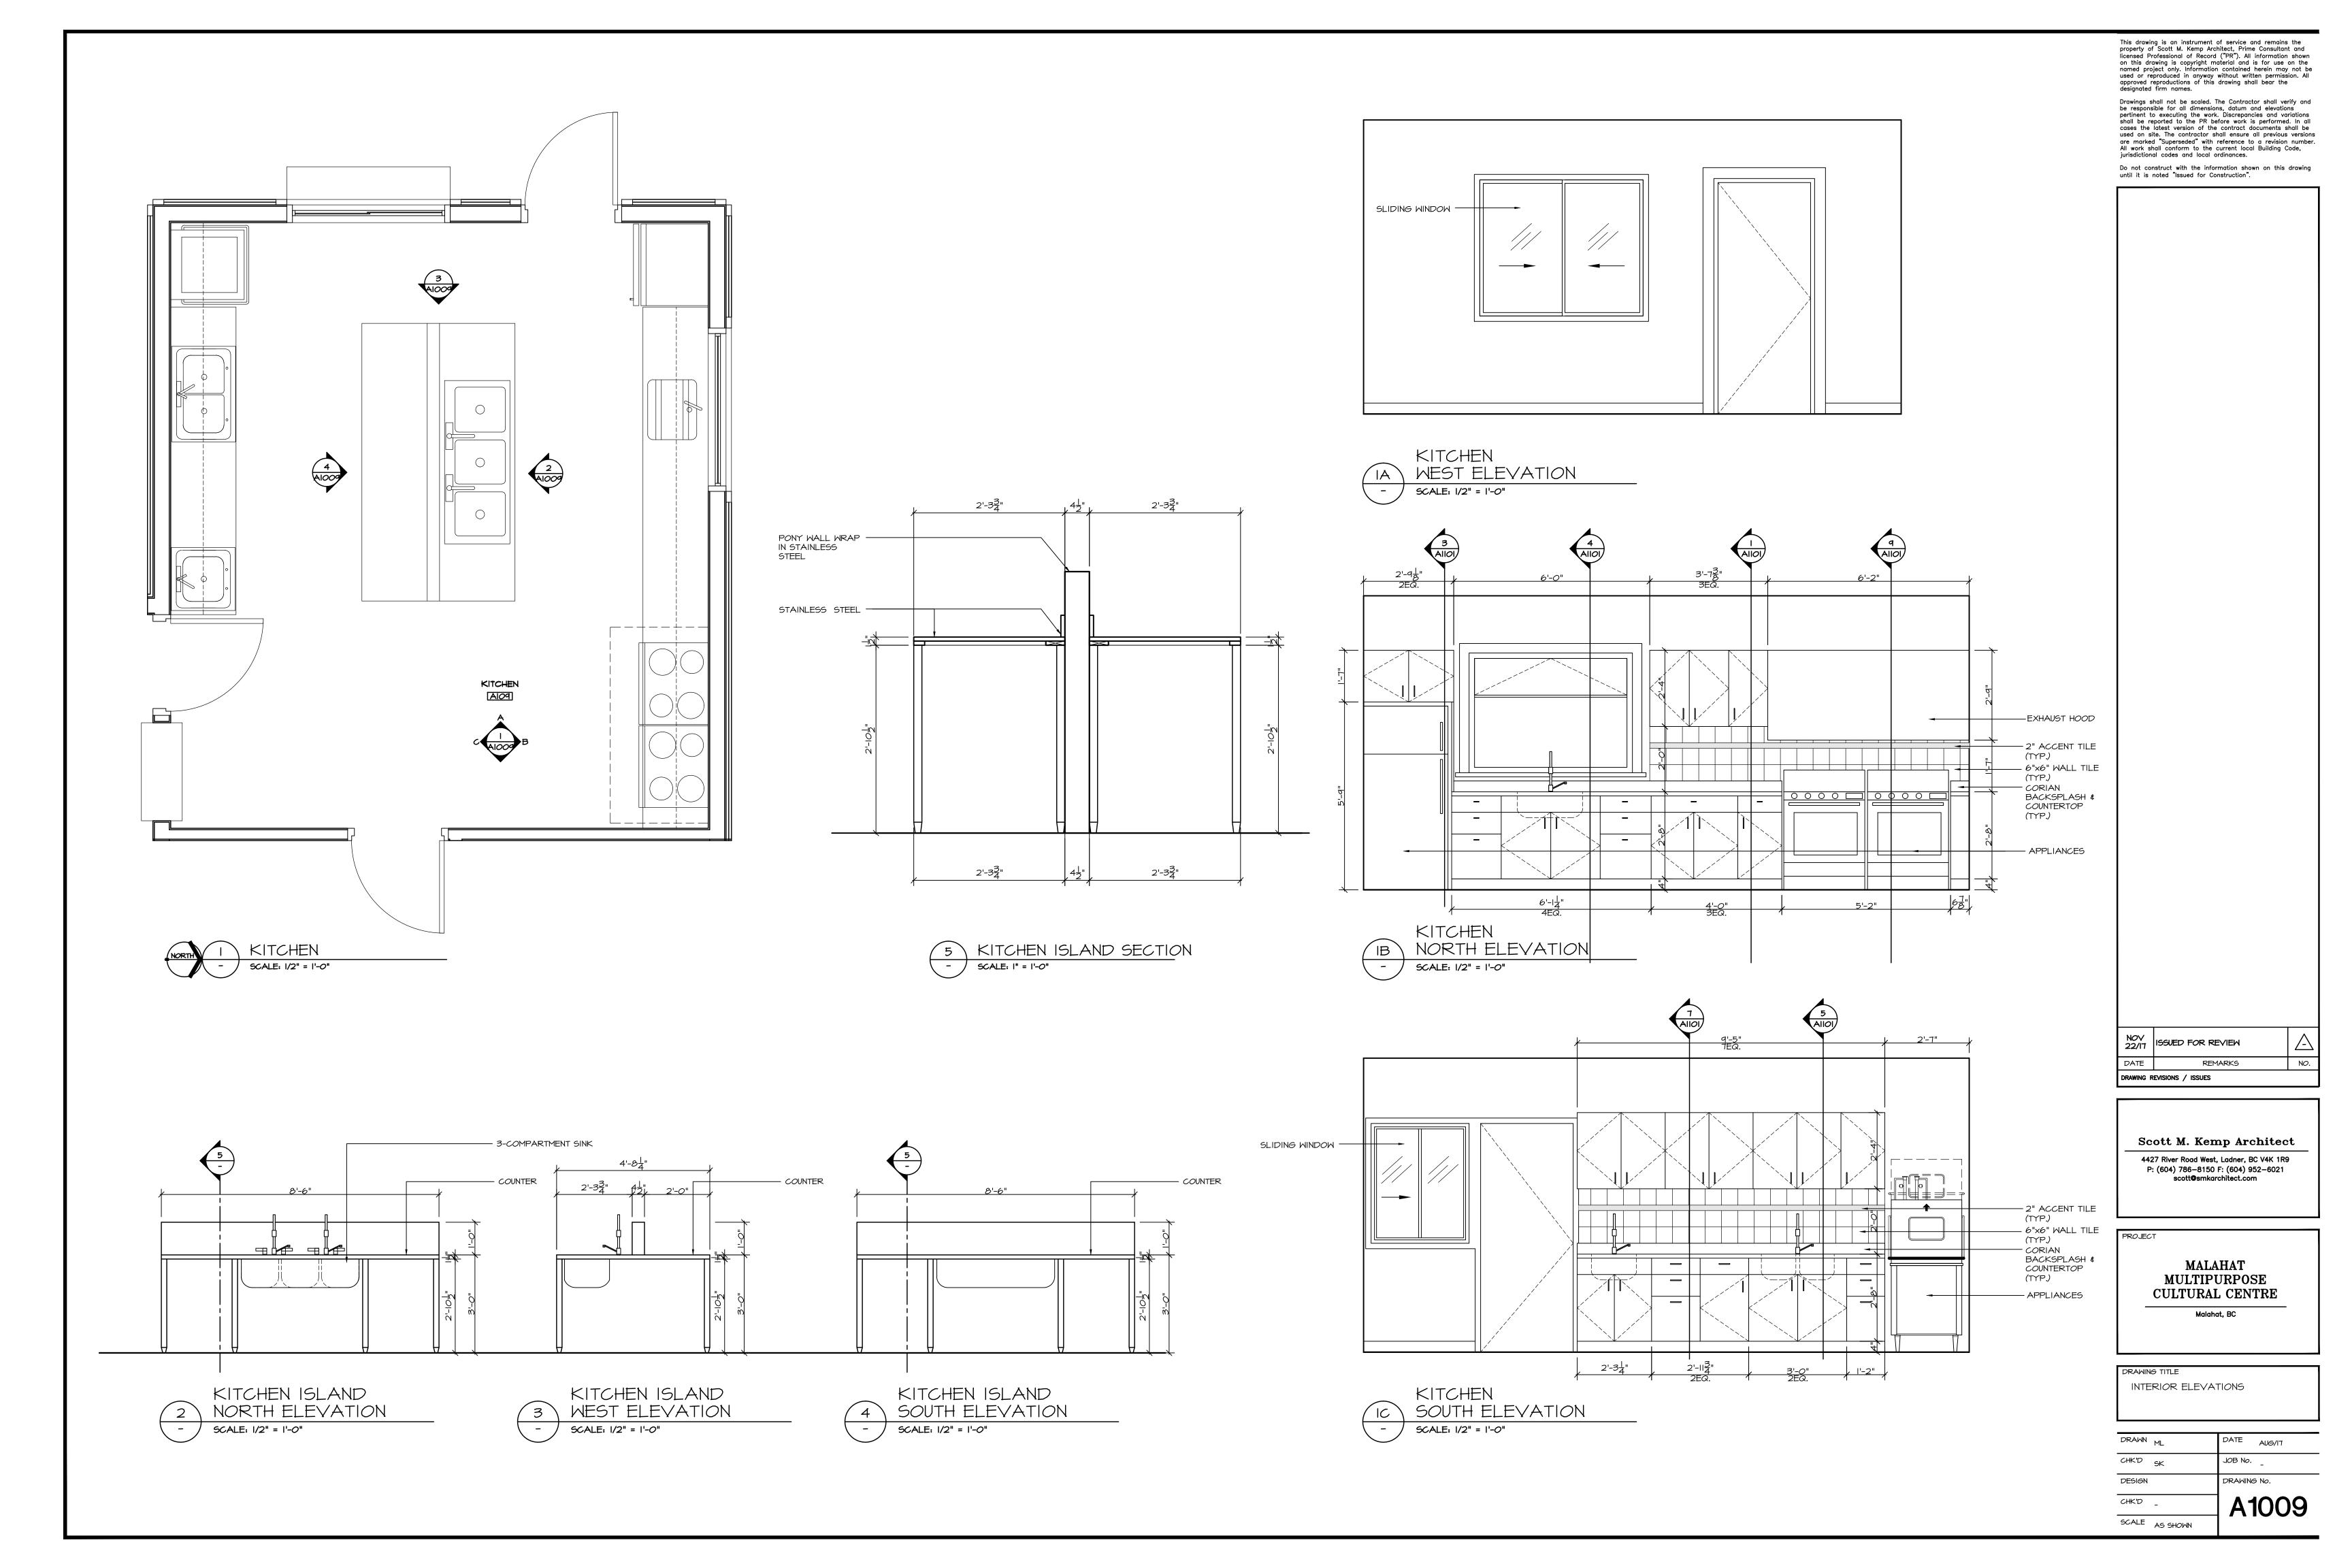

H/C TOILET

IA WEST ELEVATION


SCALE: 1/2" = 1'-0"

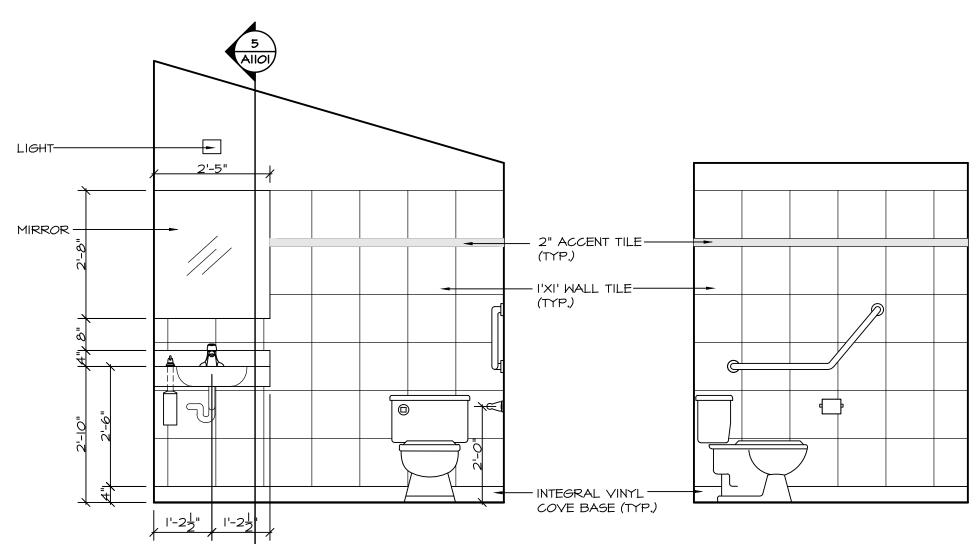

H/C TOILET

NORTH ELEVATION


- SCALE: 1/2" = 1'-0"

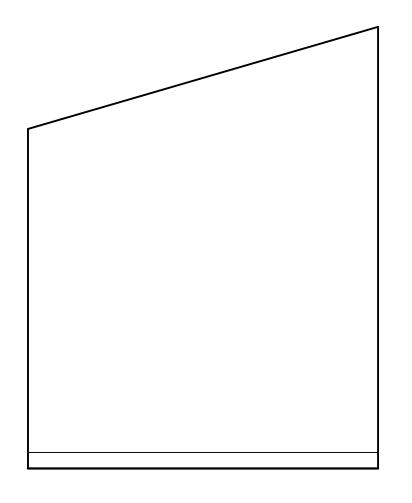

H/C TOILET

IC EAST ELEVATION

- SCALE: 1/2" = 1'-0"

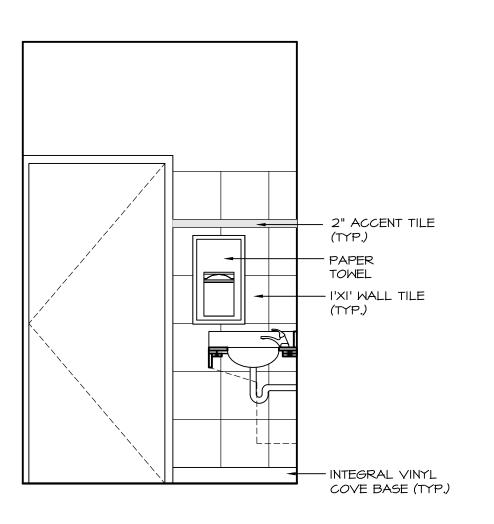

H/C TOILET

SOUTH ELEVATION

- SCALE: 1/2" = 1'-0"

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PROJECT

MALAHAT MULTIPURPOSE CULTURAL CENTRE

Malahat, BC

DRAWING TITLE

INTERIOR ELEVATIONS

DRAWN	ML	DATE	AUG/IT
CHK'D	5K	JOB No.	-
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